# **BRIGHAM YOUNG** UNIVERSITY

# WHEATLEY INSTITUTE - 3RD FLOOR RENOVATION **ADVANCEMENT VP - ALUMNI**

#### **ABBREVIATIONS**

And Angle At Centerline (a) Diameter or Round Square Feet Perpendicular Pound, Number Existing (E) Air Conditioning ACC. Access ACOUS. Acoustical ADD. Addendum ADD'L. Additional A.F.F. Above Finished Floor ALUM. Aluminum ALT. Alternate APPROX. Approximate ARCH. Architect(ural) AVG. Average BD. Board BET. Between BF. Board Feet BITUM. Bituminous BLDG. Building BLKG. Blocking CAB. Cabinet CHAM Chamfer Centerline CL CLG. Ceiling CLR. Clear(ance) CMU Concrete Masonry Unit COL. Column CONC. Concrete CONSTR Construction CONT. Continuous CONTR. Contractor DBL. Double DEMO. Demolish. Demolition DIA. Diameter DIM. Dimension DN. Down DR. Door DET. Detail DWG. Drawing EA. Each ELEC. Electric(al) ELEV. Elevation EQ. Equal EQUIP. Equipment EST. Estimate

FIN. Finish FLR. Floor FLUOR. Fluorescent FURN. Furnish, Furnished GA. Guage GYP. Gypsum HDWD. Hardwood HDWR. Hardware HORIZ. Horizontal HT. Height HVAC Heating Ventilating & A/C INSUL. Insulation Length MATL. Material MAX. Maximum MECH. Mechanical MANUF Manufacturer MIR. Mirror MISC. Miscellaneous MTL. Metal N.I.C. Not In Contract NO. Number N.T.S. Not To Scale O.C. On Center(s) OPN'G Opening OPP. Opposite O.T.S. Open To Structure P-LAM. Plastic Laminate PLBG. Plumbing PLYWD. Plywood PREFAB. Prefabricate PREFIN. Prefinished P.S.F. Pounds per Square Foot P.S.I. Pounds per Square Inch QTY. Quantity RAD. Radius REQD. Required RESIL. Resilient SPECS. Specifications SQ. Square S.S. Stainless Steel STD. STL. TYP. T.O. Standard Steel Typical Top of VAT. Vinyl Asbestos Tile VCT. VERT. Vinyl Composition Tile Vertical W/O Without SCHED. Schedule

#### SYMBOLS LEGEND

DRAWING TITLE DRAWING REFERENCE

DETAIL REFERENCE SHEET REFERENCE

ELEVATION MARKER

**REFERENCE NOTE TAG** 

ROOM TITLE ROOM NUMBER ROOM FINISHES

ROOM TITLE ROOM NUMBER CEILING HT. & FINISH

ELEVATION REFERENCE SHEET REFERENCE

NORTH SYMBOL

BRAKE LINE

SECTION REFERENCE SHEET REFERENCE

NOTE: SEE OTHER CONSULTANT DRAWINGS FOR ADDITIONAL ABBREVIATION INFORMATION

SIM.

Similar


#### **APPROVALS**

Existing

EXIST.

Matt Giles, Assistant Administrative Vice Pres. -- Physical Facilities


Steve Griffiths, Managing Director -- Physical Facilities Planning Department

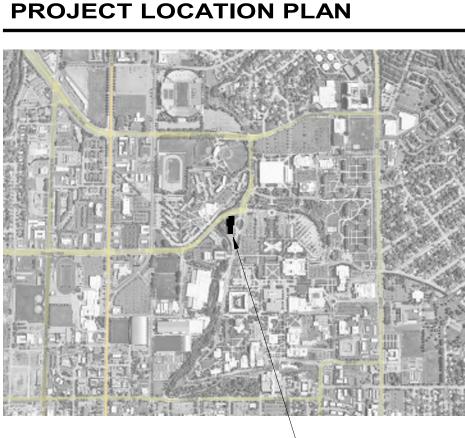

PROJECT LOCATION: HINCKLEY ALUMNI AND VISITORS CENTER

GORDON B. HINCKLEY ALUMNI AND VISITORS CENTER

NEW FLOOR PLAN SCALE: 1/4" = 1'-0"	
1 A-1	Whea
T.O. MASONRY EL. = 100' - 0"	
3	
OFFICE 100 F1 B1 W1	Institu
OFFICE 100 10'-0" C1	
4 A1.1 2	
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**TECHNOLOGY** (REFERENCE ONLY)

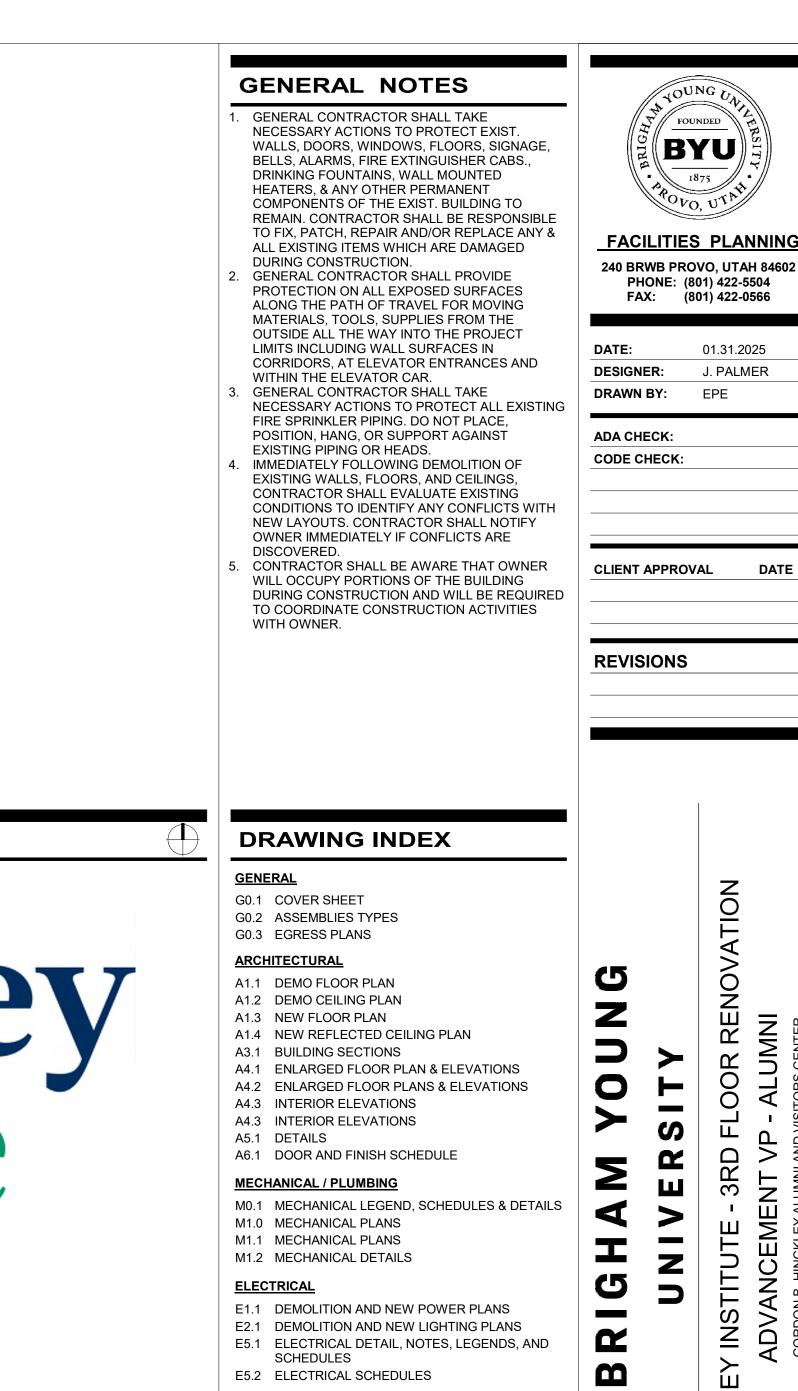- T1.1 TECHNOLOGY DEMOLITION PLAN
- T1.2 TECHNOLOGY DEMO CEILING PLAN
- T1.3 TECHNOLOGY FLOOR PLAN T1.4 TECHNOLOGY NEW REFLECTED CEILING P

**PROJECT DIRECTORY** 

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Electrical Engineer / BYU Planning:

Mechanical Engineer / BYU Planning:


Interiors / BYU Planning:

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AILS	BRIGHAM YOUNG	UNIVERSITY	WHEATLEY INSTITUTE - 3RD FLOOR RENOVATION	ADVANCEMENT VP - ALUMNI	GORDON B. HINCKLEY ALUMNI AND VISITORS CENTER
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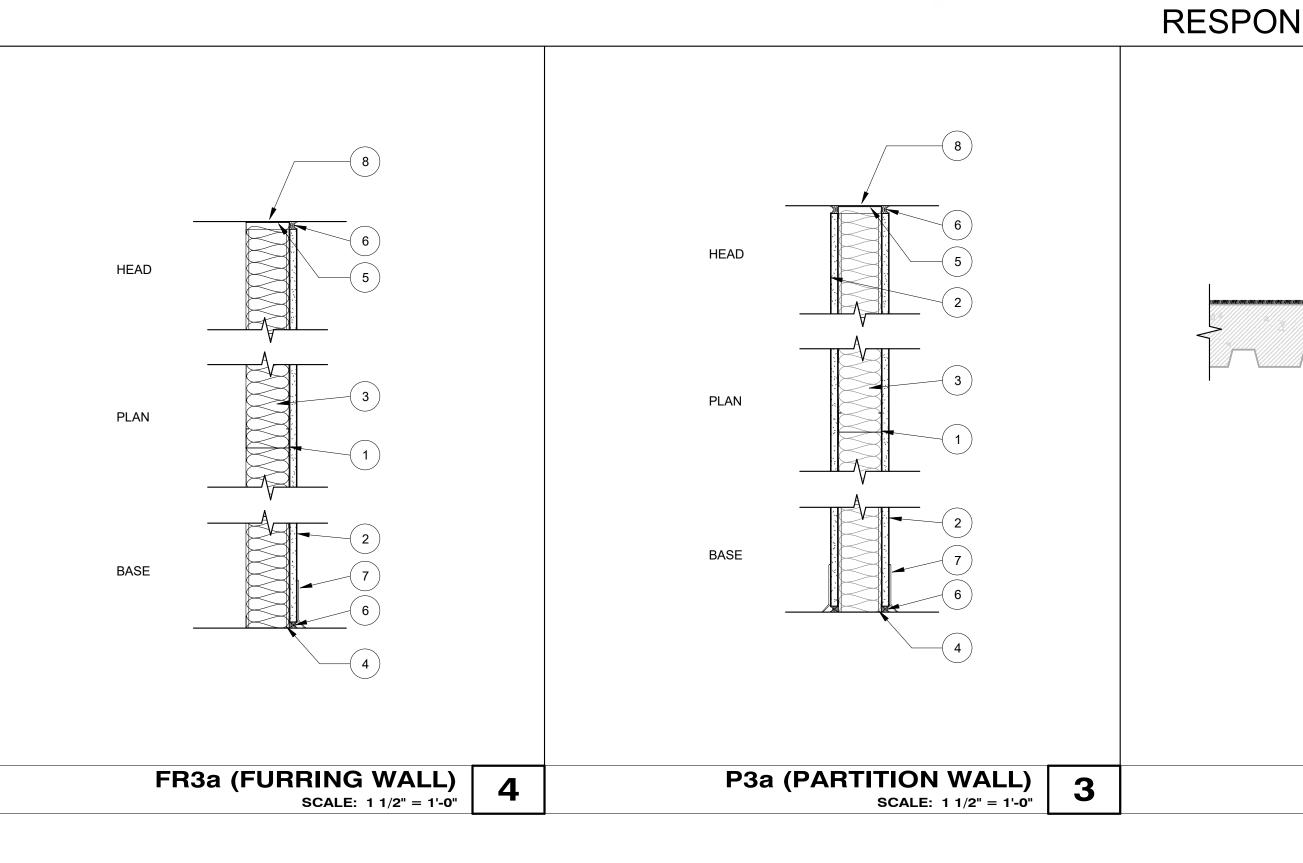
BIDDING DOCUMENTS

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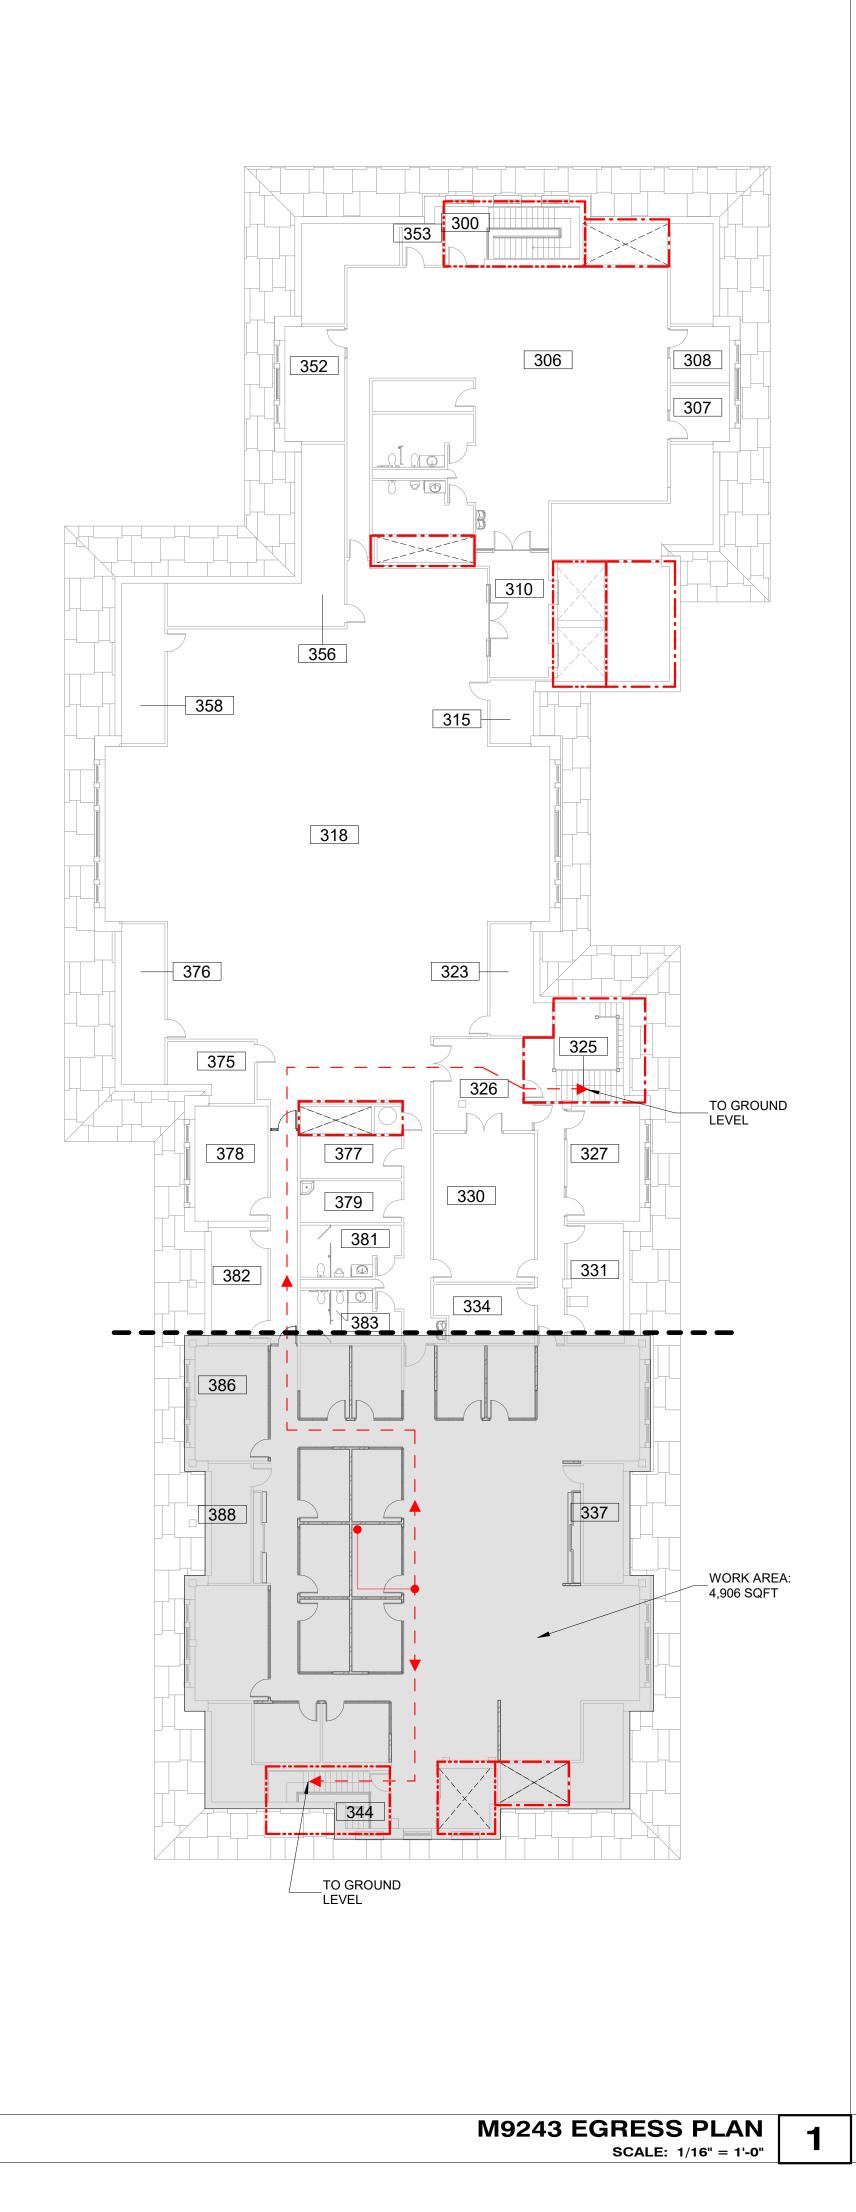



Not-In-Contract (NIC) Coordination List	Furnished by BYU	Installed by BYU / BYU Vendor	Installed by General Contractor	F b C
All Design Fees	×			T
All Printing Costs (Use established BYU printing contract)	×			t
Fees: Plan Check, Demolition Permit, Grading Permit, Building Permit, Sign Permit, Engineering Permit, Connection, and Impact	×			T
Street and Sidewalk Closure Permit, Haul Route Permit, etc.				T
Payment, Performance, and Materials Bonds				t
Asbestos and Hazardous Materials Abatement	x			t
Testing and Special Inspection Fees	×			t
Testing and Special Inspection Scheduling				t
General				T
Signage - interior and exterior	×	x		T
Removeable Core Cylinders and Keying	×	x		t
Fire Extinguisher Cabinets and Extinguishers			x	T
OIT				Г
Audio / Sound Reinforcement with mounting hardware, etc. (power and rough electrical In Contract)	×	x		T
Flat Panel Displays and Digital Signage with mounting hardware (backing, power and rough electrical In Contract)	×	x		t
CCTV Cameras with mounting hardware (power and rough electrical In Contract)	x	x		t
Smart Boards and Interactive Marker Boards with mounting hardware (power and rough electrical In Contract)	×	x		T
All AV systems (power and rough electrical In Contract)	×	x		T
All Data Pathways, Termination Boxes, Cabling, Terminations to Wall Plates and Patch Panels, Warranty			x	T
All Data Racks			x	T
All Cable Tray			x	t
Cable Pass Systems complete, Terminations, Wall Racks, Cable Hangers, Wall Plugs, Intumescent bags (1 per cable pass penetration)			x	T
Wireless Access Points (Power and Data in Contract)	x	x		T
Time Clocks - Student Employee Type (power, data, and rough electrical In Contract)	×	x		T
Interiors				t
KV type adjustable shelving			x	T
Marker boards / Tack boards			x	T
Casework and Cabinetry	×	x		T
Solid Surface Countertops	×	x		T
Systems Furniture in Offices, etc.	x	x		T
Movable Furniture and Seating	×	x		t
Carpet and Carpet Base, LVT, Rubber Base	×	x		T
Systems				T
Mechanical Controls Hardware (both system and terminal units) by Atkinson or Johnson Controls	×		×	Г
Mechanical Controls Raceway and Wiring			x	t
Mechanical Controls Programming (Software - both system and terminal units) by Atkinson or Johnson Controls	×	x		t
High Temperature Hot Water Control Valves	x		x	t
High Temperature Controls (panels and sensors)	×	x		t
Project Specific				t
Moving Existing Equipment	×			T
				t

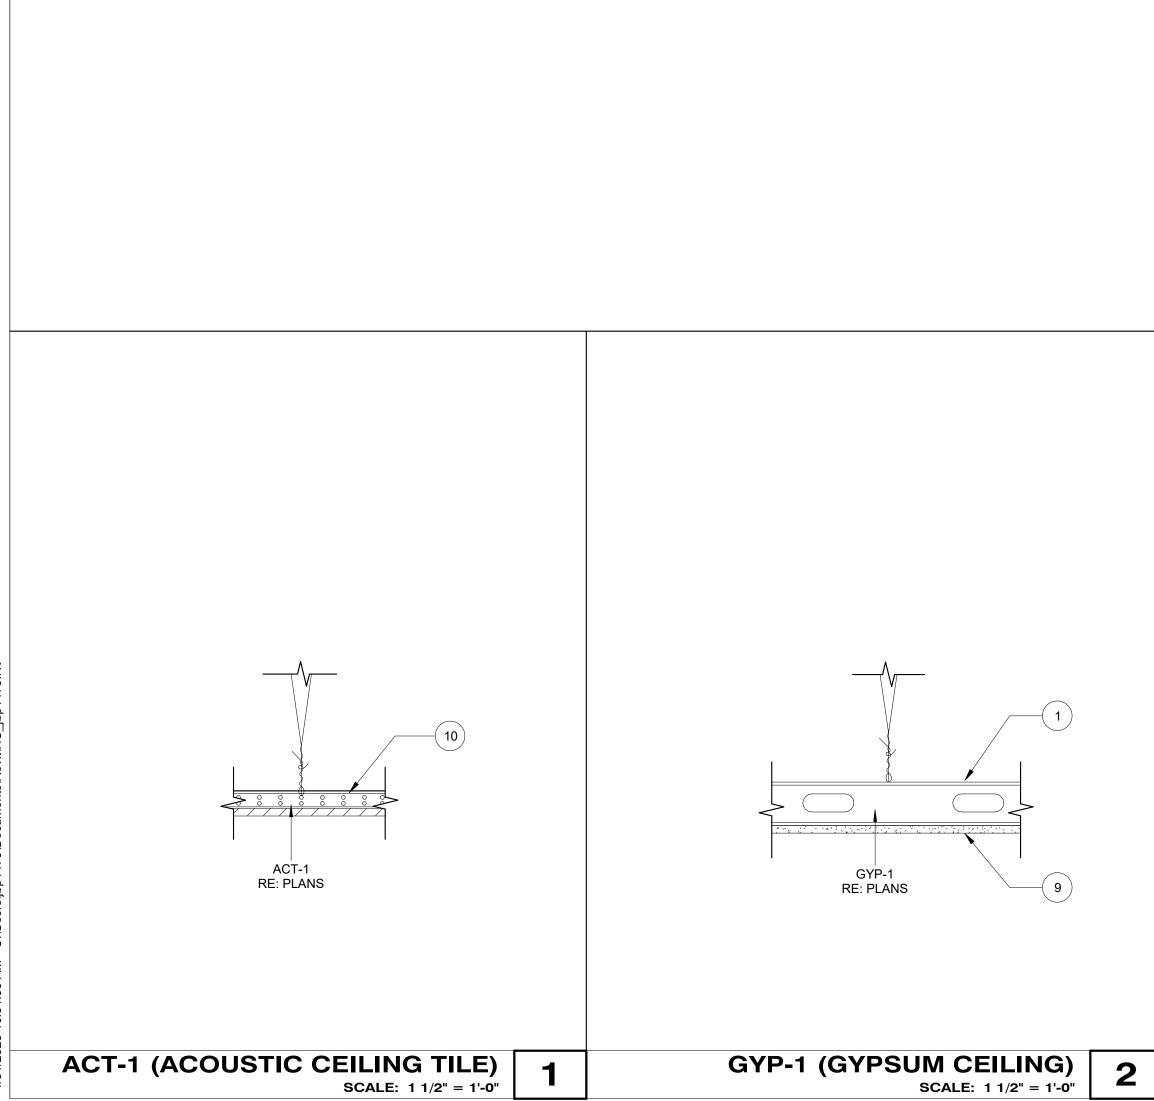



Installed by General Contractor	Furnished by General Contractor	Notes	1 2 3 4 5 6 7 8 9 10 11 12	EFERENCE NOTES ILIGHT GAUGE METAL FRAMING/STUD. SIZE INDICATED. BRACE WALL BACK TO STRUCTURE AS REQUIRED. 5/8" TYPE 'X' GYPSUM WALL BOARD. EXTEN MINIMUM OF 18" ABOVE FINISHED CEILING U.N.O. ACOUSTIC SOUND BATT INSULATION. METAL RUNNER - BOTTOM TRACK. METAL RUNNER - TOP COMPRESSION TRAC SEALANT WITH BACKER ROD. USE ACOUST SEALANT AT SOUND WALLS WALL BASE, RE: FINISH SCHEDULE. TOP OF WALL CONDITION, RE: PLANS AND DETAILS SINGLE LAYER 5/8" TYPE 'X' GYPSUM WALL/CEILING BOARD. SUSPENDED ACOUSTIC CEILING TILE (ACT) AND GRID SYSTEM. RE: FINISH SCHEDULE. EXISTING 1HR RATED COMPOSITE CONCRE FLOOR SLAB ASSEMBLY. EXISTING STRUCTURAL STEEL FRAMING SYSTEM. CARPET (NIC) INSTALLED BY BYU.	DA CK. TC	240 BRWB PRO PHONE: (80	UT NI         PLANNING         VO, UTAH 84602         01) 422-5504         01) 422-0566         01.31.2025         J. PALMER         MDL
x x x x x x x x x				FILING         EXISTING WALL - TO REMAIN         EXISTING WALL - DEMOLISH         NEW MTL STUD WALL, RE: WALL TYPE         OORS         EXISTING DOOR - TO REMAIN         EXISTING DOOR - TO REMAIN         NEW DOOR         NEW DOOR         ELLINGS         SLOPED GYP CEILING - DEMOLISH         EXISTING CEILING - TO REMAIN         EXISTING CEILING - TO REMAIN         EXISTING CEILING - DEMOLISH         NEW CEILING         PENDANT LIGHT FIXTURE - EXISTING TO REMAIN         PENDANT LIGHT FIXTURE - EXISTING TO REMAIN         PENDANT LIGHT FIXTURE - REMOVE AND SALVAGE         PENDANT LIGHT FIXTURE - REINSTALLED         LAY-IN LIGHT FIXTURE (SIZE VARIES) - DEMOLISH         MECHANICAL DIFFUSER/GRILLE	PΕ	BRIGHAM YOUNG UNIVERSITY	WHEATLEY INSTITUTE - 3RD FLOOR RENOVATION ADVANCEMENT VP - ALUMNI GORDON B. HINCKLEY ALUMNI AND VISITORS CENTER
				<ul> <li>LINEAR SLOT DIFFUSER - EXISTING</li> <li>LINEAR SLOT DIFFUSER - DEMOLISH</li> <li>CONCEALED FIRE SPRINKLER HEAD</li> <li>EXIT SIGNAGE</li> <li>WIRELESS ACCESS POINT</li> </ul>		ASSEMBL WORK ORDER M92 G(	243


HINCKLEY CENTER - 3RD FLOOR




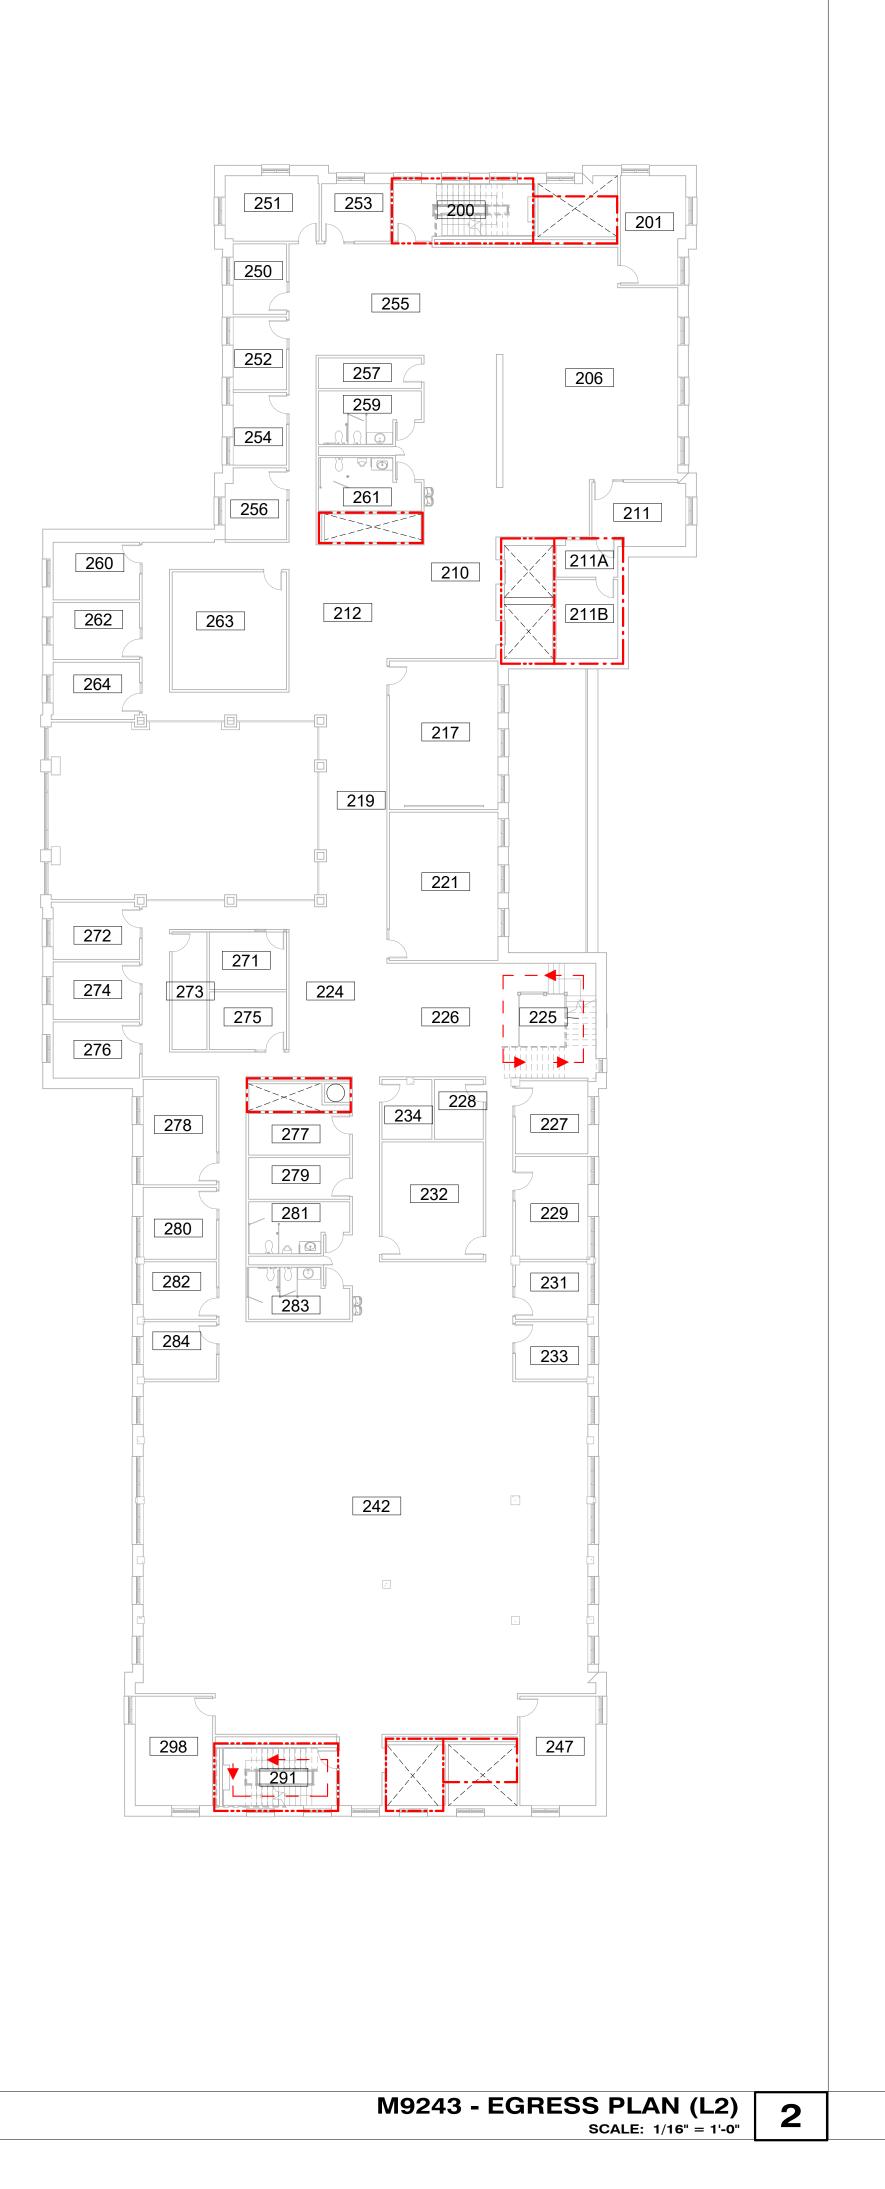

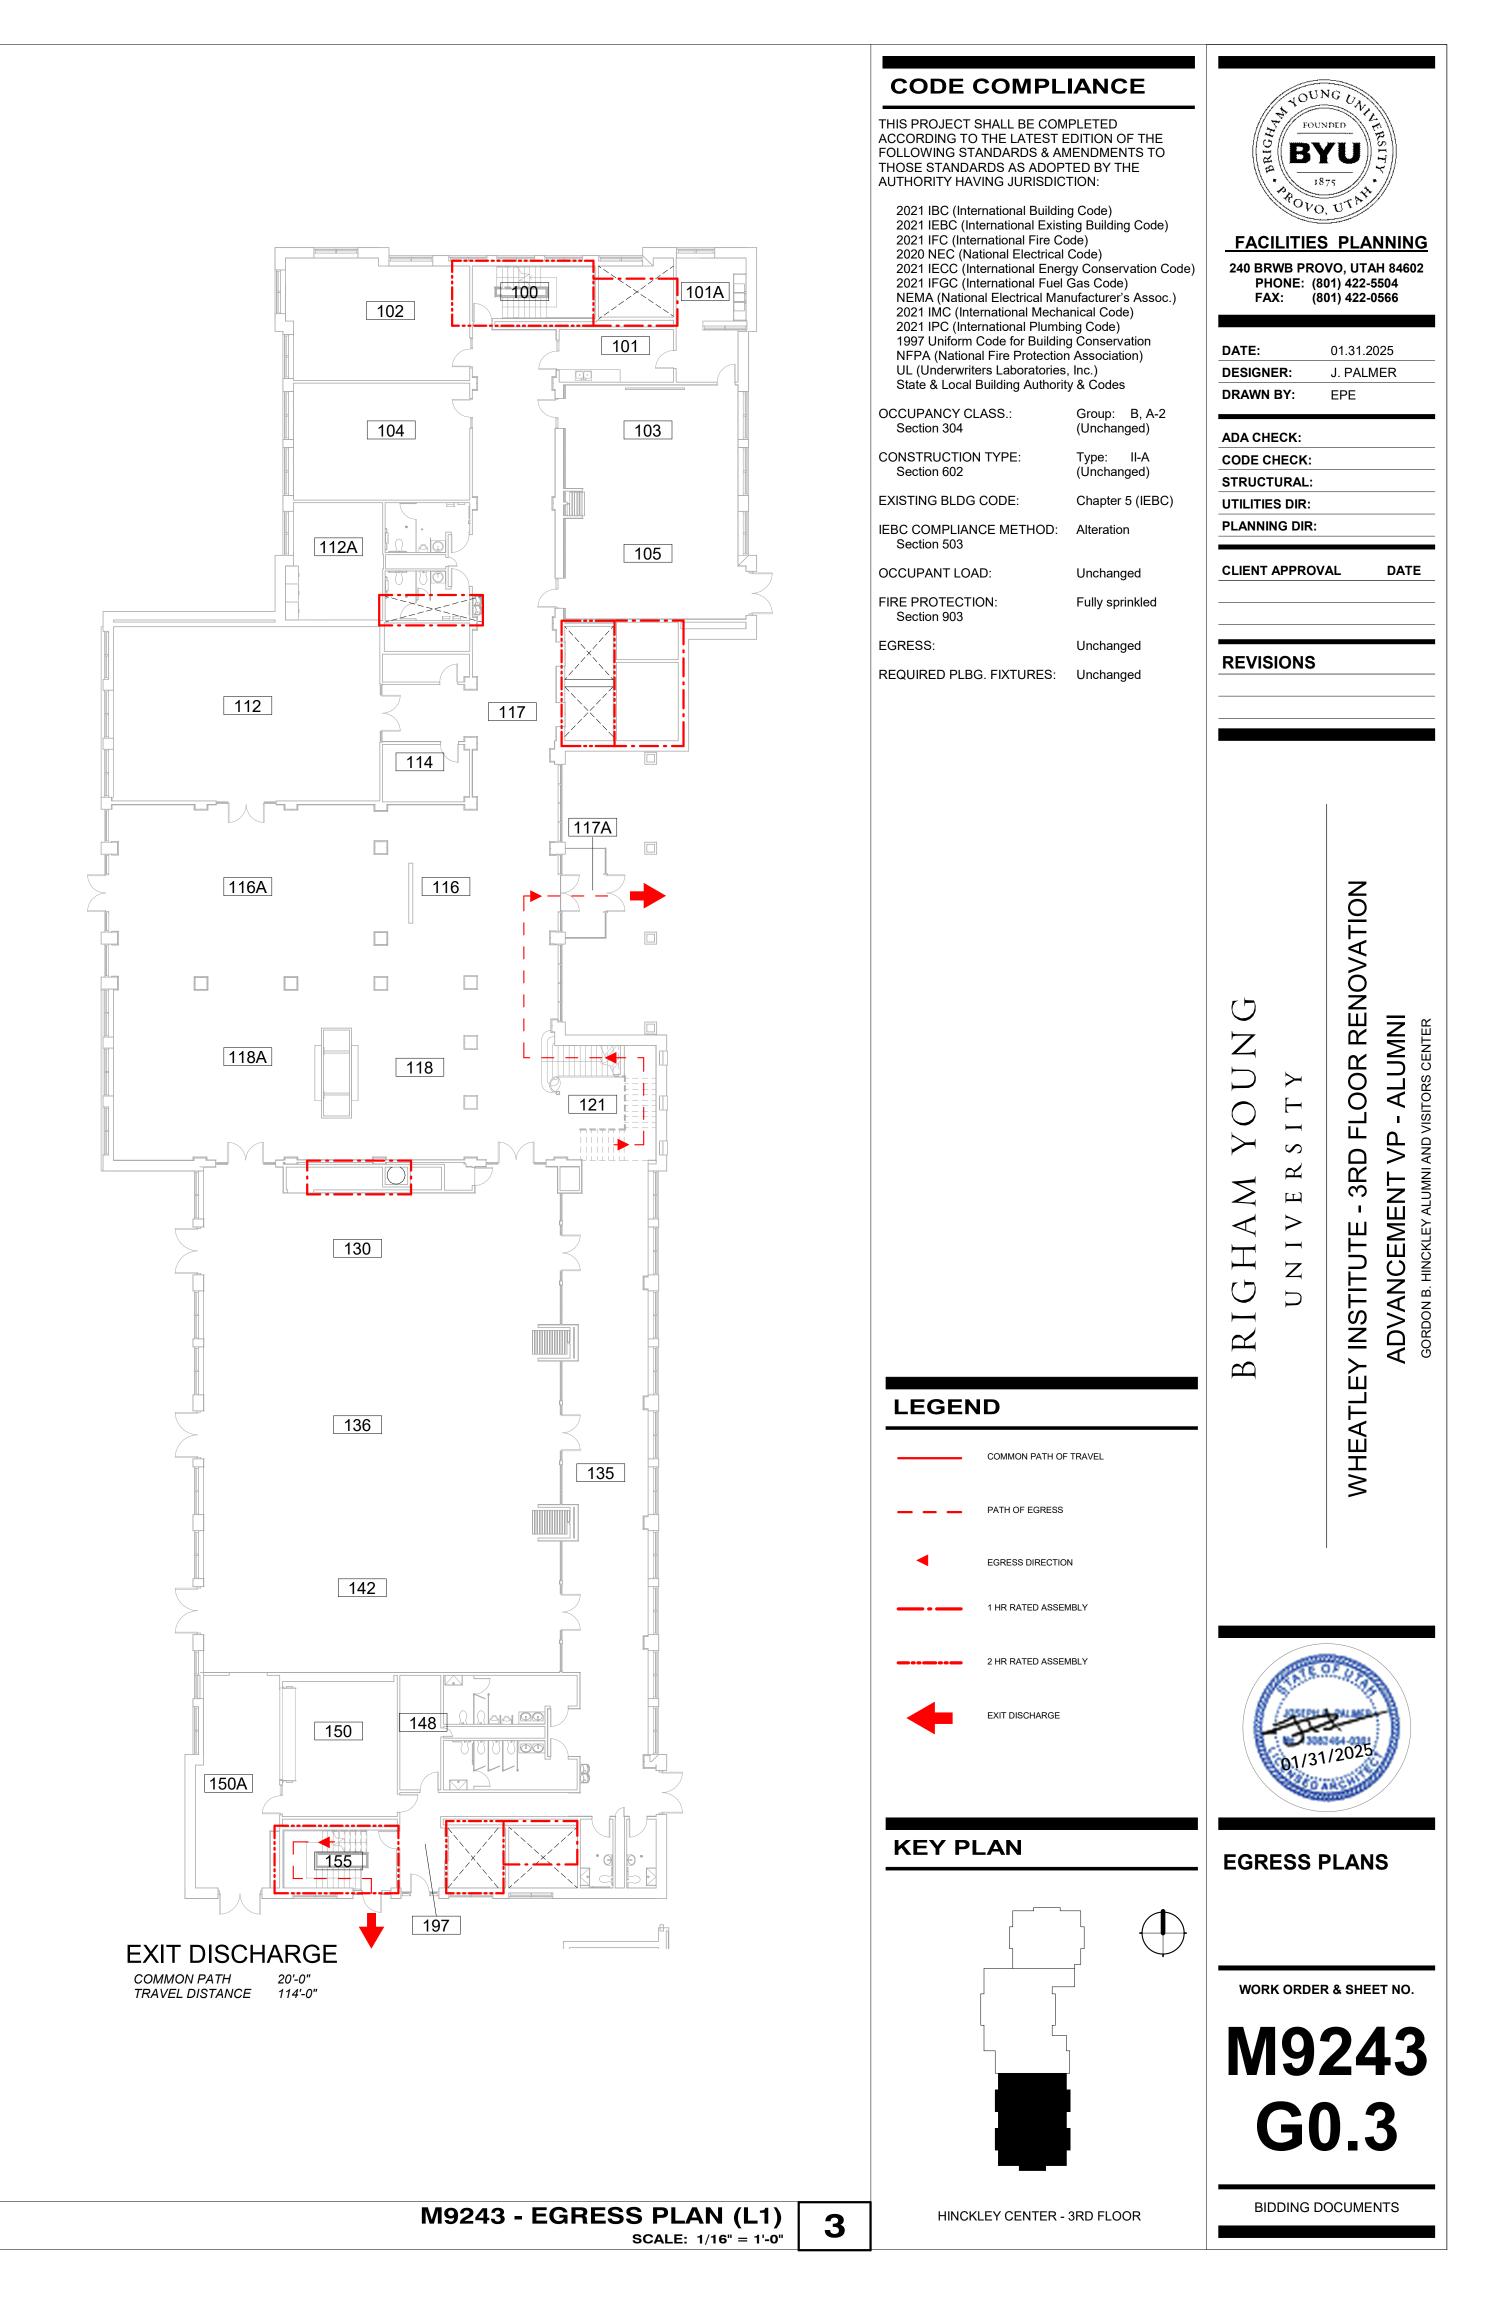

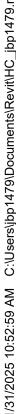

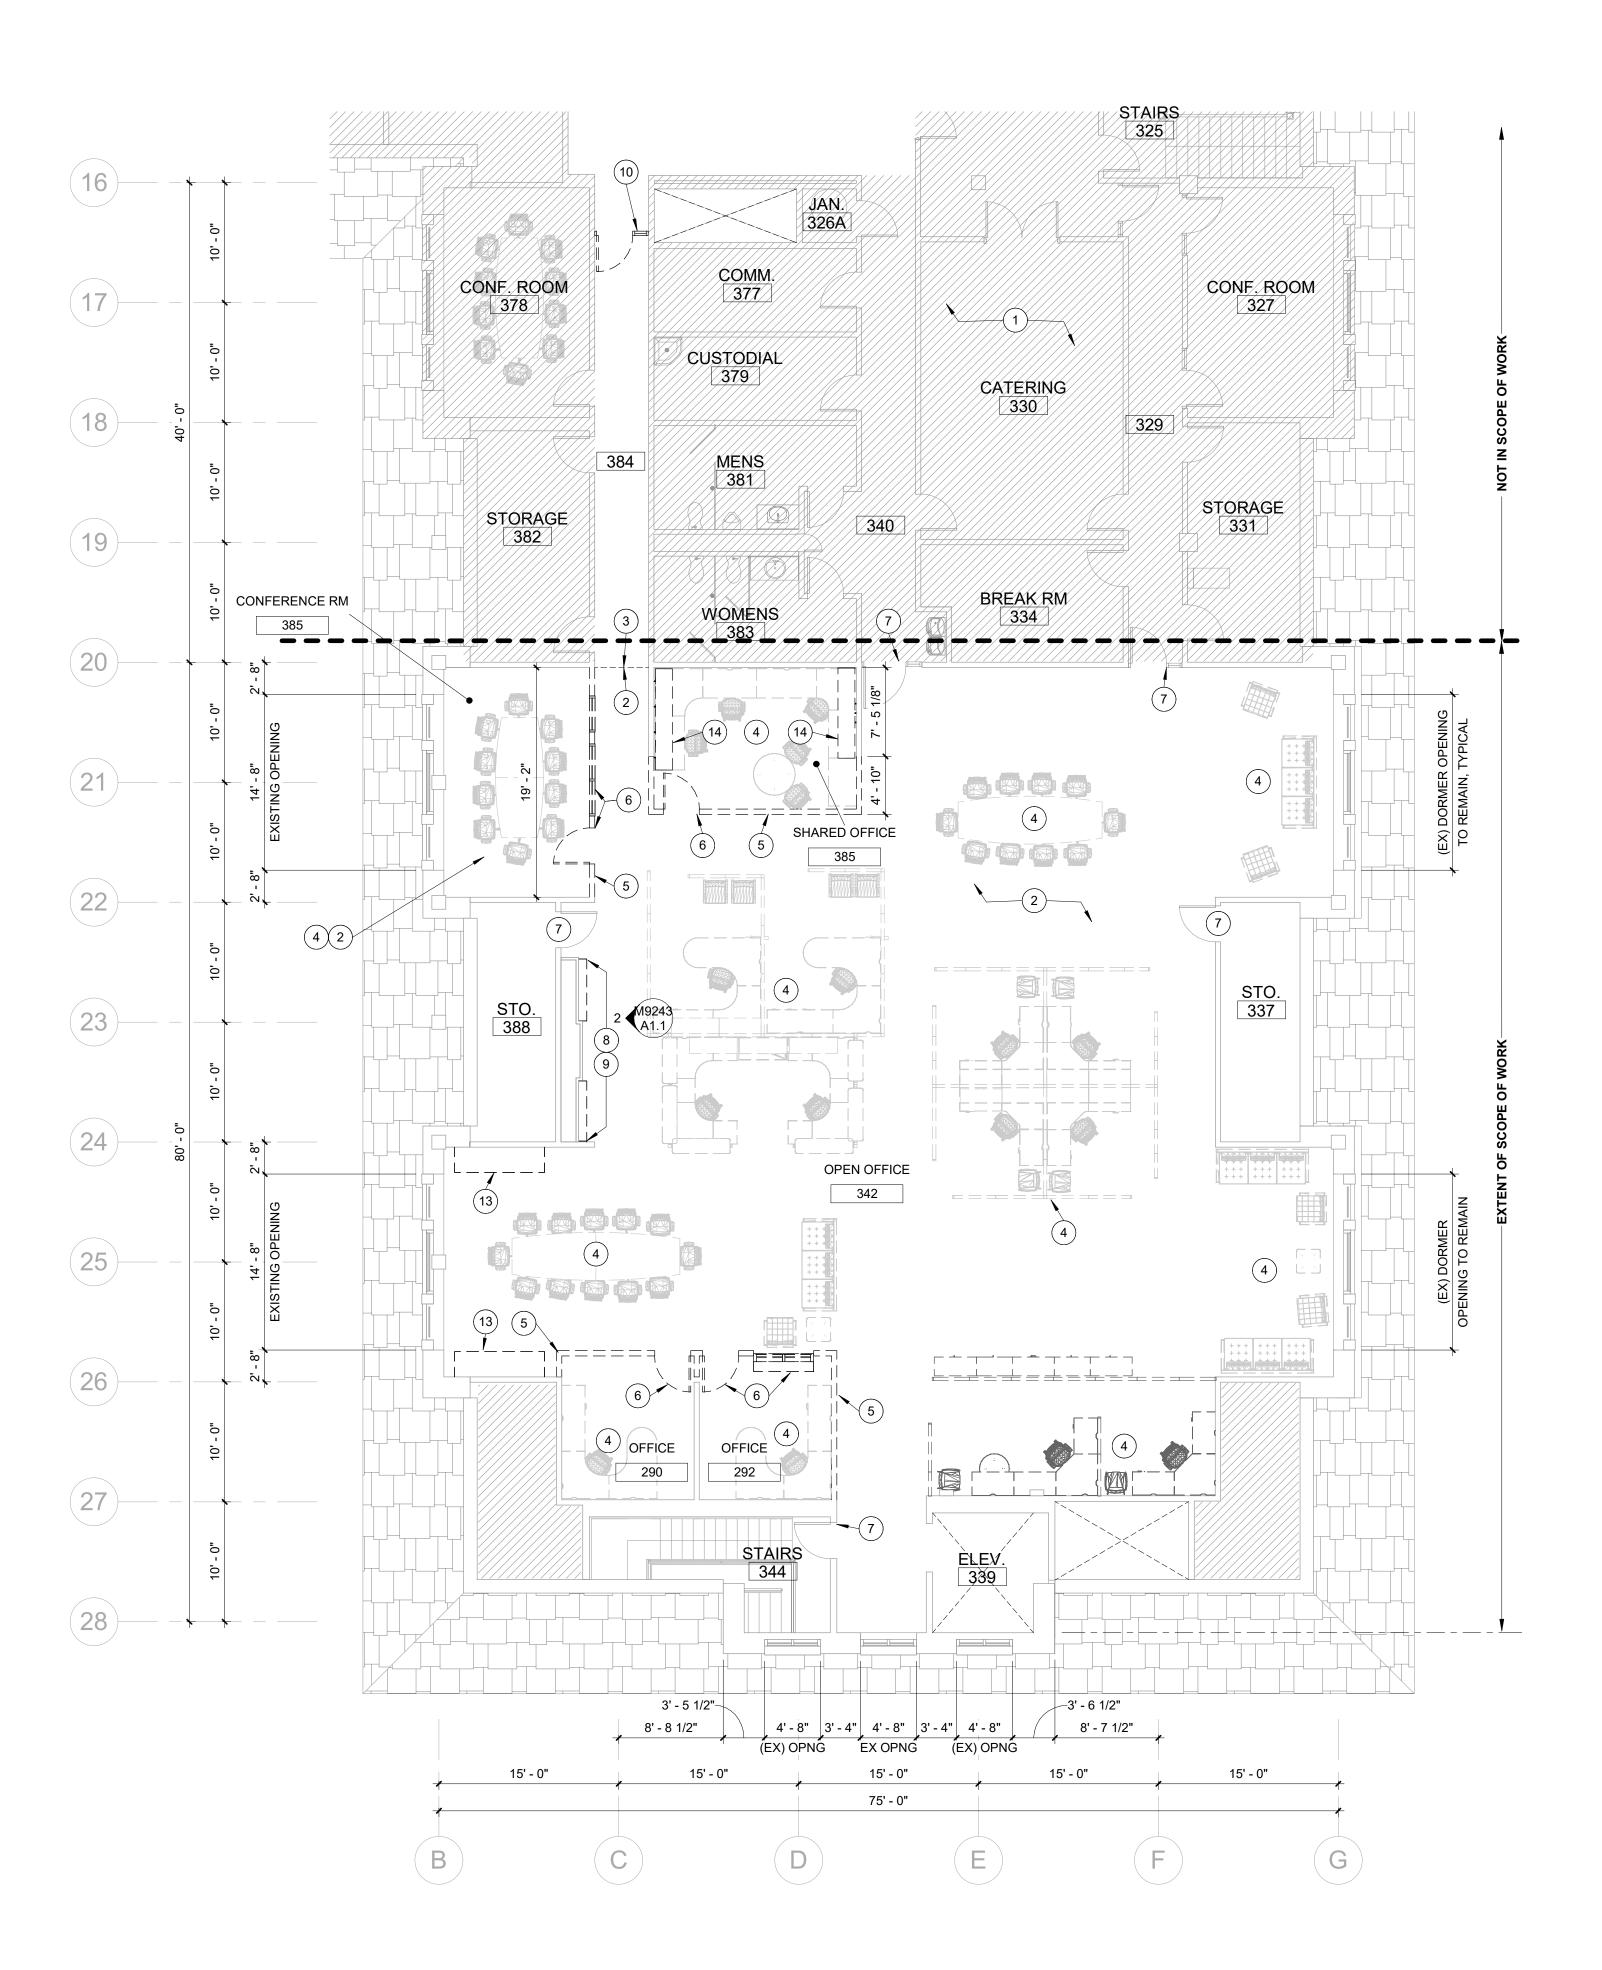

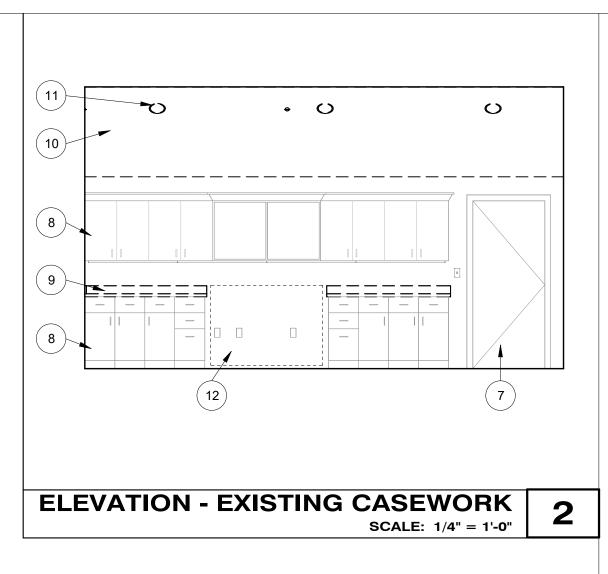

#### **GENERAL NOTES**

- START OF DEMOLITION ACTIVITIES. 2. REFER TO RESPONSIBILITY MATRIX FOR ITEMS UNDER THE GENERAL CONTRACTOR'S SCOPE OF WORK AND ITEMS UNDER THE OWNER'S SCOPE OF
- WORK.
  GENERAL CONTRACTOR SHALL TAKE NECESSARY ACTIONS TO PROTECT EXIST. WALLS, DOORS, WINDOWS, FLOORS, SIGNAGE, BELLS, ALARMS, FIRE EXTINGUISHER CABS., DRINKING FOUNTAINS, WALL MOUNTED HEATERS, & ANY OTHER PERMANENT COMPONENTS OF THE EXIST. BUILDING TO REMAIN. CONTRACTOR SHALL BE RESPONSIBLE TO FIX, PATCH, REPAIR AND/OR REPLACE ANY & ALL EXISTING ITEMS WHICH ARE DAMAGED DURING CONSTRUCTION.
- GENERAL CONTRACTOR SHALL TAKE
   GENERAL CONTRACTOR SHALL TAKE NECESSARY ACTIONS TO PROTECT ALL EXISTING FIRE SPRINKLER PIPING. DO NOT PLACE, POSITION, HANG, OR SUPPORT AGAINST EXISTING PIPING OR HEADS.
- 5. REMOVE ALL EXISTING CONDITIONS AS INDICATED AND REQUIRED TO COMPLETE THE PROPOSED SCOPE OF NEW CONSTRUCTION.
- REMOVE ALL DEMOLITION MATERIALS FROM THE BUILDING AND OFF SITE WITHOUT DAMAGE TO THE BUILDING OR ITS FINISHES.
   IMMEDIATELY FOLLOWING DEMOLITION OF EXISTING WALLS, FLOORS, AND CEILINGS, CONTRACTOR SHALL EVALUATE EXISTING CONDITIONS TO IDENTIFY ANY CONFLICTS WITH NEW LAYOUTS. CONTRACTOR SHALL NOTIFY OWNER IMMEDIATELY IF CONFLICTS ARE DISCOVERED.

#### **REFERENCE NOTES**

- DIAGONAL HATCH REGIONS INDICATE AREA NOT IN SCOPE OF WORK. TYPICAL.
   REMOVE AND DISPOSE OF EXISTING CARPET THROUGHOUT WHEATLEY INSTITUTE SPACE
- THROUGHOUT WHEATLEY INSTITUTE SPACE.PREP SURFACE FOR NEW CARPET.3 EXISTING CARPET TO REMAIN; PROTECT
- FROM CONSTRUCTION ACTIVITIES
   REMOVE AND SALVAGE ALL FURNITURE WITHIN WHEATLEY INSTITUTE SPACE, RETURN AND COORDINATE STORAGE
- LOCATION WITH HINCKLEY CENTER.
  5 REMOVE AND DISPOSE OF WALL SYSTEM OR PORTION THEREOF. RELOCATE ANY ELECTRICAL AND TECHNOLOGY DEVICES ARE REQUIRED FOR NEW LAYOUT.
- 6 REMOVE AND DISPOSE OF EXISTING HM DOOR/WINDOW FRAME.
- 7 EXISTING HM DOOR TO REMAIN. PROTECT DURING CONSTRUCTION. RE: DOOR SCHEDULE FOR DOORS TO RECEIVE NEW HARDWARE.
   8 EXISTING UPPER AND LOWER CASEWORK
- a EXISTING OPPER AND LOWER CASEWORK AND MOLDING TO REMAIN, PROTECT DURING CONSTRUCTION.
   9 REMOVE AND DISPOSE OF EXISTING SOLID
- 10 DEMOLISH PORTION OF SLOPED GYP. BD.
- CEILING AS INDICATED BY CROSSHATCH PATTERN.
- 11 DISCONNECT AND REMOVE RECESSED CAN LIGHT FIXTURE, RE: ELECTRICAL.
- EXISTING SLOPED GYP. BD CEILING (DORMER CONDITION) TO REMAIN. PROTECT AS REQ'D.
   REMOVE AND SALVAGE EXISTING
- 13 REMOVE AND SALVAGE EXISTING CASEWORK, COORDINATE WITH OWNER SALVAGING.
   14 REMOVE AND SALVAGE WALL MOUNTED
- 14 REMOVE AND SALVAGE WALL MOUNTED STANDARDS AND SHELVING, COORDINATE WITH OWNER FOR SALVAGING.

#### LEGEND


#### WALLS

- EXISTING WALL TO REMAIN
- = = EXISTING WALL DEMOLISH
- NEW MTL STUD WALL, RE: WALL TYPE

#### DOORS

- EXISTING DOOR TO REMAIN

**KEY PLAN** 

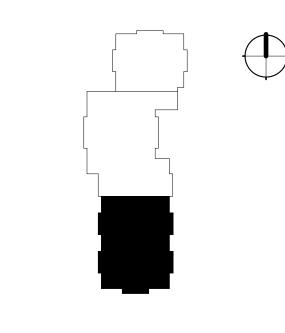


FOUNDED BYU 1875 FACILITIES PLANNING 240 BRWB PROVO, UTAH 84602 PHONE: (801) 422-5504 FAX: (801) 422-0566 DATE: 01.31.2025 DESIGNER: J. PALMER DRAWN BY: EPE/MDL ADA CHECK: CODE CHECK: STRUCTURAL: UTILITIES DIR: PLANNING DIR: CLIENT APPROVAL DATE REVISIONS OOR RENOVATION ALUMNI  $\smile$ 4  $\square$ Ο  $\bigcap$ Ш Η  $\boldsymbol{\mathcal{O}}$  $\square$ >  $\mathbf{R}$ Ľ  $\overline{}$ Ш  $\boldsymbol{\triangleleft}$ MEN  $\geq$ Ш Γ Z  $\mathbf{O}$  $\mathcal{O}$  $\supset$ S Ž  $\simeq$ AD A  $\succ$  $\mathbf{D}$ Ш WHEATL

JOUNG






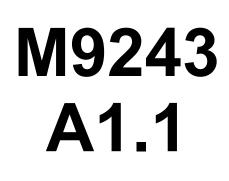

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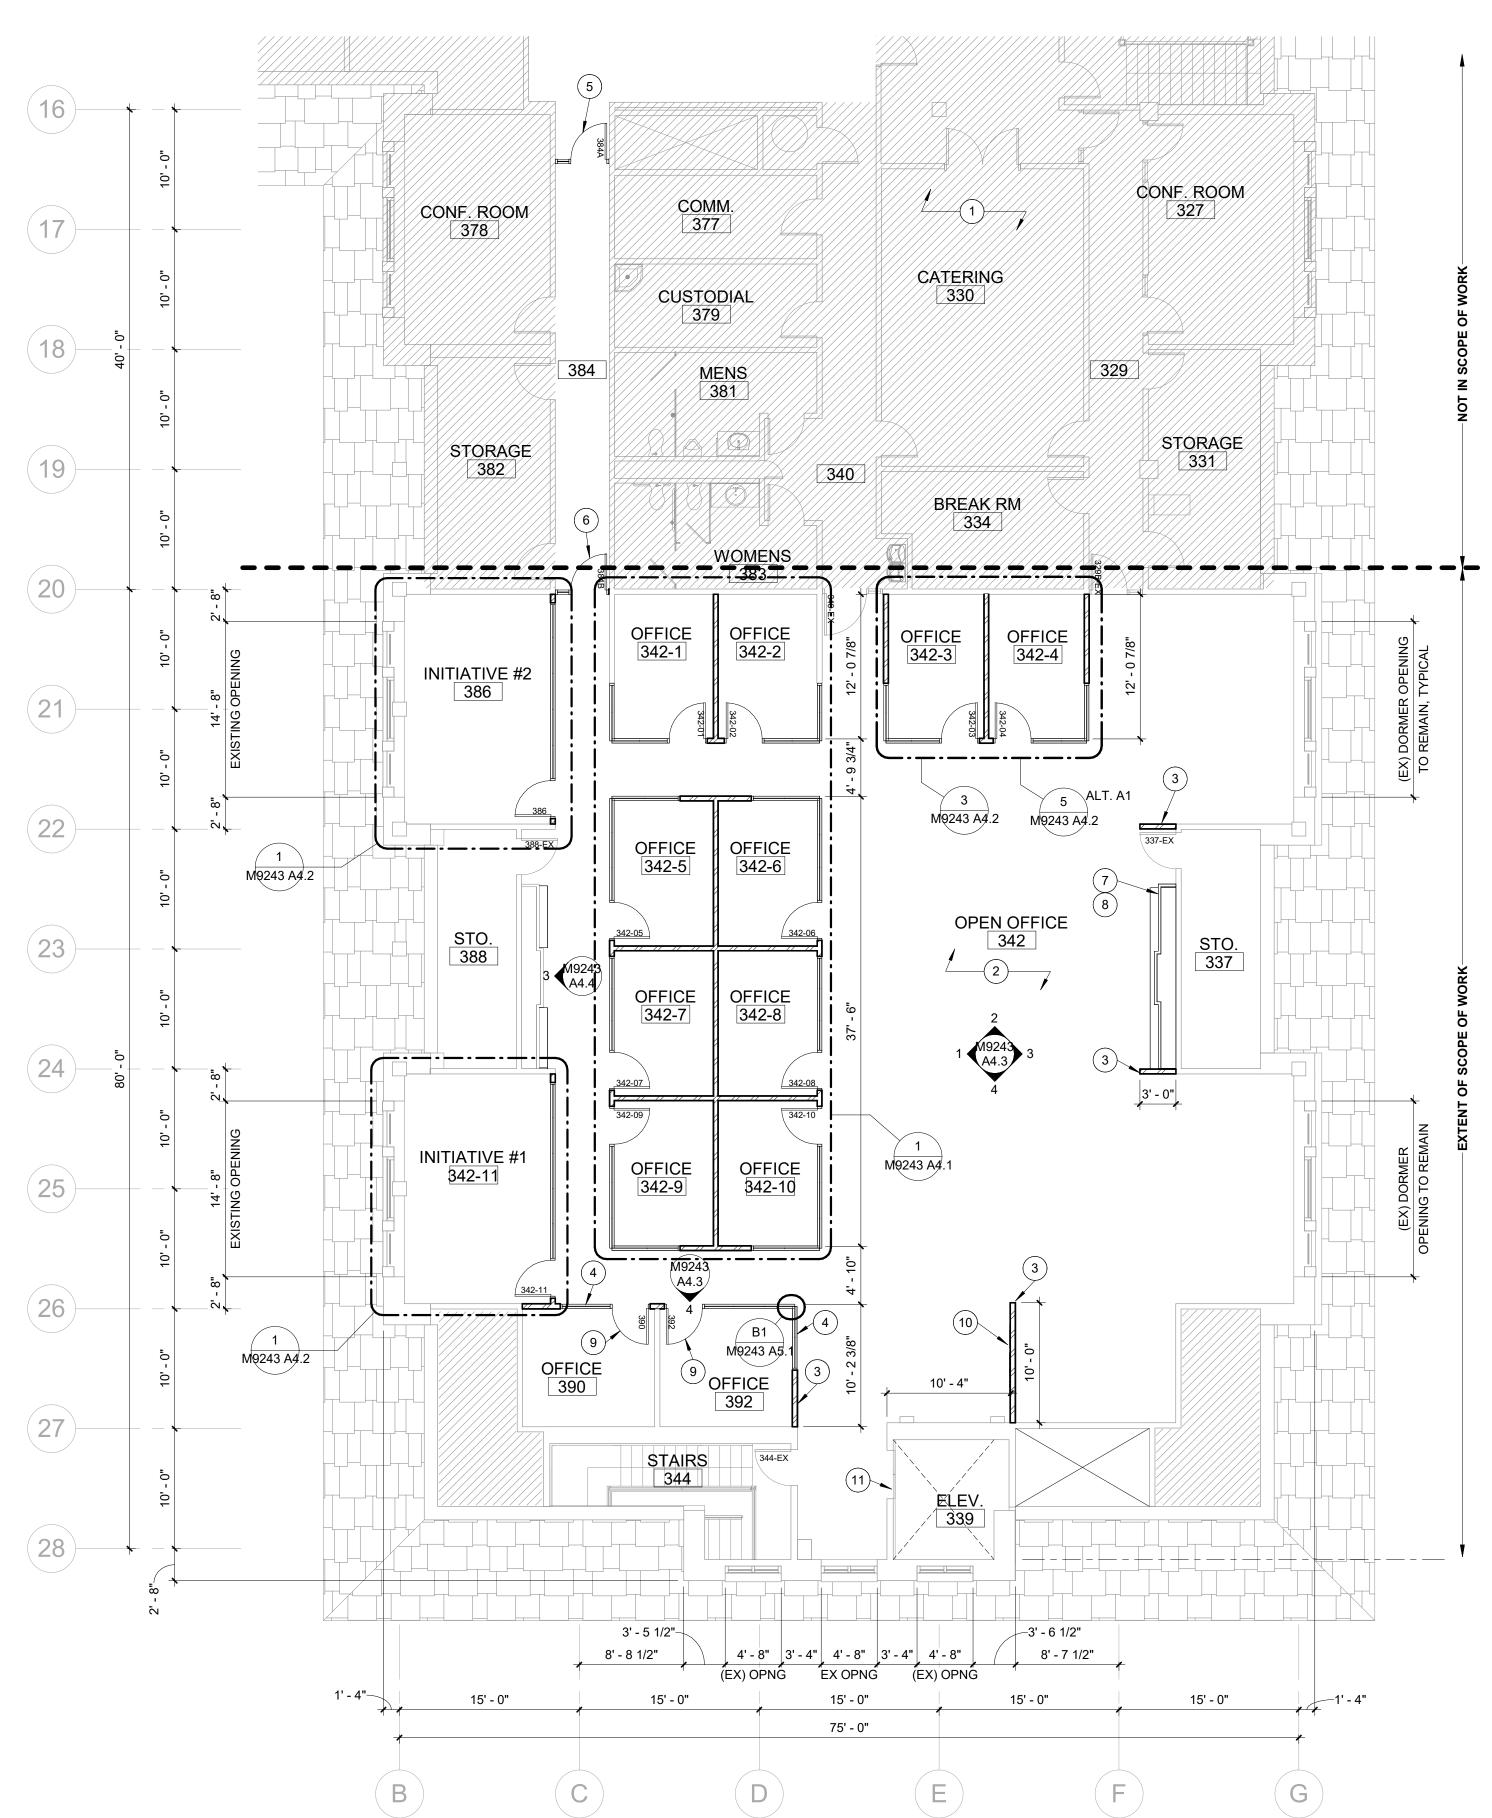
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SCALE: 1/8" = 1'-0"



#### **REFERENCE NOTES** JOUNG FOUNDED 1 DIAGONAL HATCH REGIONS INDICATE AREA BYU NOT IN SCOPE OF WORK. TYPICAL. 2 CAREFULLY REMOVE EXISTING HM DOOR & FRAME FROM WALL. FLIP DOOR/FRAME 180 3875 DEGREES SO THAT DOOR SWING IS IN THE $(\circ_{VO}, \upsilon)$ DIRECTION OF EGRESS (SEE NEW FLOOR PLAN) AND RE-MOUNT DOOR. 3 EXISTING OWNER EQUIPMENT TO REMAIN. FACILITIES PLANNING PROTECT AS REQ'D. 240 BRWB PROVO, UTAH 84602 4 EXISTING LINEAR PENDANT LIGHT FIXTURE PHONE: (801) 422-5504 TO REMAIN, RE: ELECTRICAL. FAX: (801) 422-0566 5 EXISTING RECESSED CAN LIGHT FIXTURE TO BE REMOVED AND REPLACED WITH NEW RECESSED LED FIXTURE. RE: ELECTRICAL PLANS. DATE: 01.31.2025 6 EXISTING LINEAR DIFFUSER TO REMAIN. DESIGNER: J. PALMER PROTECT AS REQUIRED. RE: MECHANICAL. 7 EXISTING LINEAR DIFFUSER TO BE REMOVED DRAWN BY: EPE AND REPLACED WITH SHORTER LENGTH SLOT DIFFUSER THAT MATCHES EXISTING ADA CHECK: SLOT DIFFUSERS IN BUILDING. RE: MECHANICAL. CODE CHECK: 8 EXISTING LINEAR DIFFUSER TO REMAIN. STRUCTURAL: PROTECT AS REQUIRED. RE: MECHANICAL. 9 EXISTING CONCEALED FIRE SPRINKLER TO UTILITIES DIR: REMAIN IN PLACE. PROTECT AS REQUIRED. PLANNING DIR: RE: PLUMBING. 10 EXISTING CONCEALED FIRE SPRINKLER HEAD TO BE MODIFIED/RELOCATED PER NEW CLIENT APPROVAL DATE FLOOR PLAN LAYOUT. IN AREAS WHERE CEILING HEIGHT WAS LOWERED PIPE, SPRINKLER PIPING WILL NEED TO BE EXTENDED TO LOWER CEILING HEIGHT. RE: PLUMBING 11 EXISTING LINEAR PENDANT LIGHT FIXTURE REVISIONS TO BE REMOVED AND SALVAGED. PREP FOR NEW SHORTER LENGTH LINEAR LIGHT FIXTURE TO BE INSTALLED IN SAME PLACE WHERE INDICATED ON NEW FLOOR PLAN, RE: ELECTRICAL. 12 EXIT SIGNS, WAP, SMOKE DETECTORS, AND OTHER CEILING MOUNTED DEVICES ARE TO BE TEMPORARILY REMOVED AND REINSTALLED IN NEW LOCATIONS AS INDICATED PER DRAWINGS. 13 EXISTING GYP. BOARD CEILING SOFFIT TO REMAIN. PATCH, REPAIR, AND PAINT ANY AREA THAT RECEIVE DAMAGE AS A RESULT OF CONSTRUCTION ACTIVITIES. TION RENOVA Ζ $\mathbf{C}$ $\square$ $\cap$ H LEGEND Γ $\boldsymbol{\mathcal{S}}$ $\square$ > $\mathbf{R}$ $\mathbf{C}$ CEILINGS $\overline{}$ Y INSTITUTE - 3 ADVANCEMEN Ш $\triangleleft$ SLOPED GYP CEILING - DEMOLISH $\triangleleft$ $\geq$ Γ $\Box$ **EXISTING CEILING - TO REMAIN** Ζ $\mathcal{O}$ Ν + - + $\begin{array}{c} | \\ + - + \end{array}$ EXISTING CEILING - DEMOLISH $\simeq$ NEW CEILING $\succ$ В ш PENDANT LIGHT FIXTURE -WHEATLI EXISTING TO REMAIN PENDANT LIGHT FIXTURE REMOVE AND SALVAGE PENDANT LIGHT FIXTURE -REINSTALLED • • LAY-IN LIGHT FIXTURE (SIZE VARIES) - DEMOLISH LAY-IN LIGHT FIXTURE (SIZE VARIES) MECHANICAL DIFFUSER/GRILLE LINEAR SLOT DIFFUSER - EXISTING ■ = = LINEAR SLOT DIFFUSER - DEMOLISHED CONCEALED FIRE SPRINKLER HEAD EXIT SIGNAGE ⊘ WIRELESS ACCESS POINT **KEY PLAN DEMO CEILING** PLAN $( \downarrow )$ WORK ORDER & SHEET NO. **M9243** A1.2 BIDDING DOCUMENTS

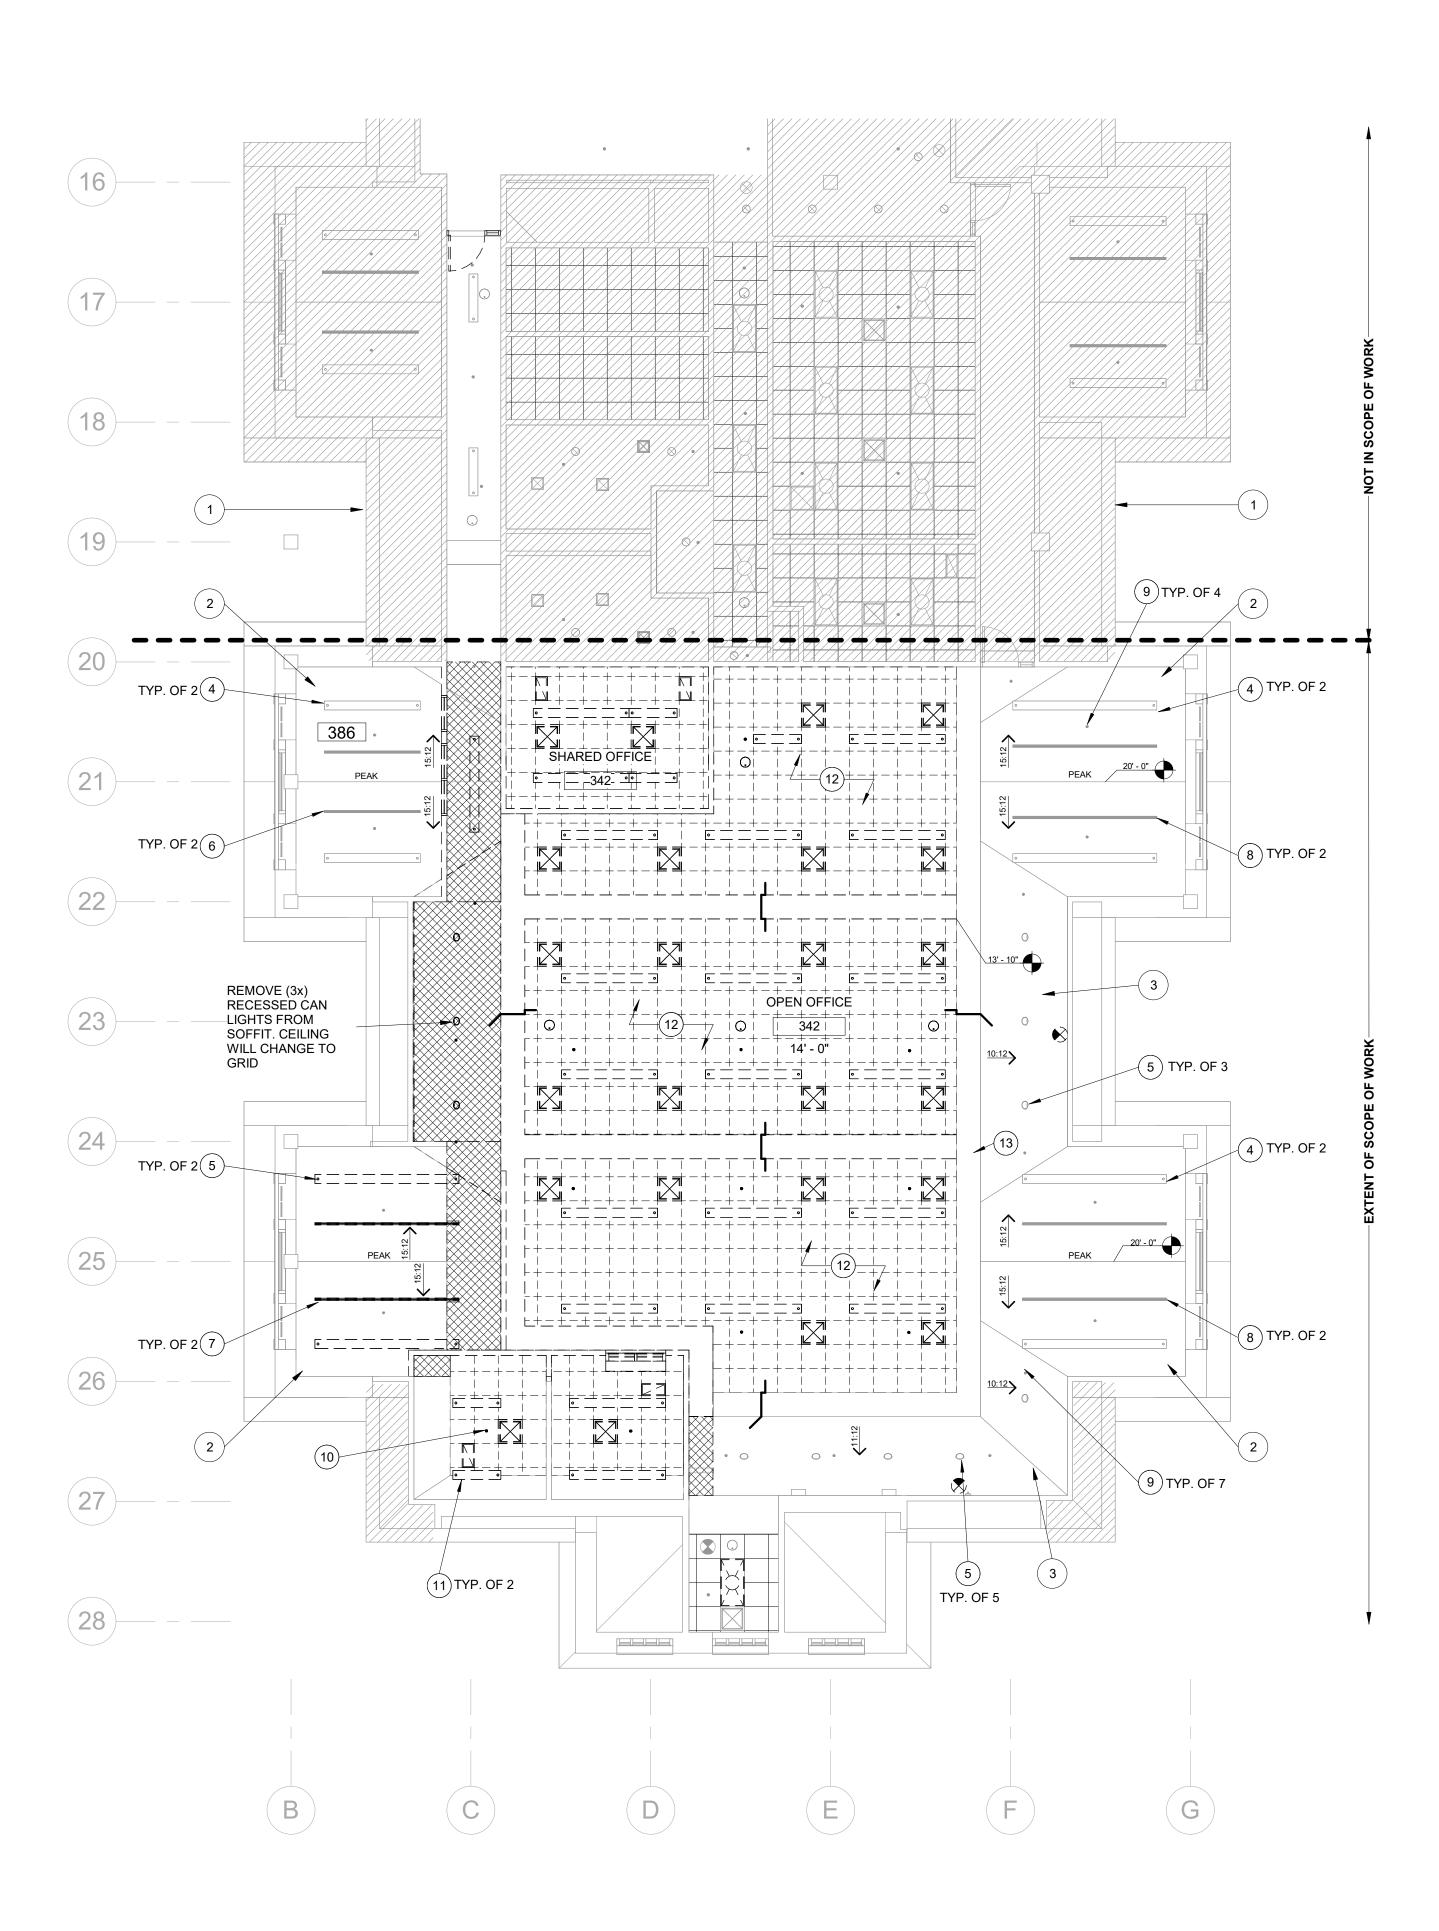
- 3ND FLOON 3001H SCALE: 1/8" = 1'-0"



CONTRACTOR TO VERIFY WITH BYU PRIOR TO ANY NEW PENETRATIONS THROUGH FLOOR.

NOTE: BYU TO EVALUATE ANY EXISTING FLOOR PENETRATIONS WITHIN SCOPE OF WORK AND COORDINATE WITH CONTRACTOR ON ANY PENETRATIONS THAT WILL NO LONGER BE USED AND WILL REQUIRE TO BE GROUTED AND FILLED

M9243 A3.1 2 M9243 A3.1 3 M9243 A3.1

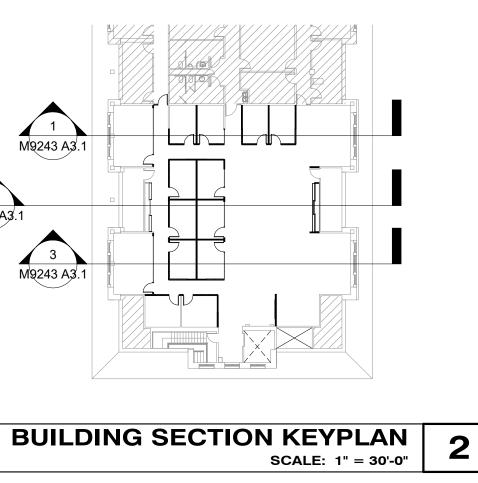

#### **GENERAL NOTES**

- 1. REFER TO RESPONSIBILITY MATRIX FOR A BREAKDOWN ON SCOPE OF WORK. GENERAL CONTRACTOR SHALL COORDINATE WITH OWNER FOR ALL ITEMS OUTSIDE THEIR SCOPE.
- 2. ALL DIMENSIONS SHOWN ON DRAWINGS FOR NEW WALLS ARE TO FACE OF STUD. FOR EXISTING WALLS, DIMENSIONS ARE TO FACE OF WALL SURFACE.
- WALL SURFACES SHOWN ON DRAWINGS THAT APPEAR TO BE FLUSH WITH AN EXISTING WALL ARE INDEED FLUSH. GENERAL CONTRACTOR TO COORDINATE INSTALLATION OF FRAMING SO THAT FINISH WALL SURFACE
- REMAINS FLUSH 4. AT WALL TRANSITIONS FROM EXISTING TO NEW, PATCH AND/OR REPLACE GYP. BOARD AS REQUIRED TO PROVIDE A FLUSH AND SEAMLESS TRANSITION BETWEEN WALL SURFACES.
- 5. WHERE LOWER PORTIONS OF THE ROOF STRUCTURE EXIST, EXTEND NEW WALLS UP AND ATTACH TO STRUCTURE. WHERE IT IS NOT FEASIBLE TO EXTEND WALLS UP DUE TO ROOF STRUCTURE HEIGHT THE GENERAL CONTRACTOR SHALL PROVIDE DIAGONAL BRACING BACK TO STRUCTURE AS REQUIRED.
- ROOM ID SIGNAGE TO BE PROVIDED AND INSTALLED BY BYU. GENERAL CONTRACTOR TO PROVIDE IN WALL BLOCKING FOR ALL WALL MOUNTED EQUIPMENT (CABINETS, ACCESSORIES, HARDWARE, ETC.). WOOD BLOCKING OR 16
- GA. METAL STRAPPING (SECURED TO 3 STUDS MINIMUM) IS ACCEPTABLE. GENERAL CONTRACTOR TO PROVIDE FIRESTOPPING/CAULKING AT ALL NEW PENETRATIONS THROUGH EXISTING WALLS AND FLOORS. PENETRATIONS THROUGH NEW
- WALLS SHOULD BE SEALED/CAULKED AS REQUIRED.

**REFERENCE NOTES** 

NOT IN SCOPE OF WORK. TYPICAL.

1 DIAGONAL HATCH REGIONS INDICATE AREA

STANDARD CARPET TILES THROUGHOUT

3 NEW MTL STUD FRAMED WALL (RE WALL TYPE ASSEMBLY). EXTEND AND SECURE WALL UP

SYSTEM WITH BUTT GLAZED GLASS PANELS.

RE: STOREFRONT ELEVATIONS AND SPECS.

5 REMOVE AND REINSTALL DOOR WITH DOOR

SWING IN OPPOSITE DIRECTION SO THAT DOOR SWINGS OUT INTO OPEN EVENT SPACE. 6 NEW 3'-0" X 7'-0" HM DOOR & FRAME WITH

SIDELITE. RE DOOR SCHEDULE AND FRAME

8 N.I.C. - NEW SOLID SURFACE COUNTERTOP TO

BE FURNISHED AND INSTALLED BY OWNER,

RE: FINISH SCHEDULE. COORDINATE ABOVE

7 N.I.C. - NEW UPPER AND LOWER CABINETRY

TO BE FURNISHED AND INSTALLED BY OWNER, RE: INTERIOR ELEVATIONS.

COUNTER ELECTRICAL RECEPTACLES.

NEW FLUSH WOOD DOOR PROVIDED. RE:

10 DIMENSIONAL SIGNAGE USING WHEATLEY

11 CONTRACTOR TO PROVIDE PROTECTION OF

ALL SURFACES WITHIN ELEVATOR CAR AND ELEVATOR ENTRANCES.

DOOR SCHEDULE AND DOOR PANEL

TYPE FONT FACE. MOUNT USING 1"

STANDOFFS FROM WALL. RE: SPECS.

SPACE. RE: RESPONSIBILITY MATRIX.

4 NEW ALUMINUM FRAMED STOREFRONT

TO 12" ABOVE HIGHEST CEILING.

2 GENERAL CONTRACTOR TO PREP FLOOR FOR NEW FLOORING INSTALLATION. BYU TO PROVIDE AND INSTALL NEW HC BUILDING

#### DESIGNER: J. PALMER DRAWN BY: EPE ADA CHECK: CODE CHECK: STRUCTURAL: UTILITIES DIR: PLANNING DIR: CLIENT APPROVAL DATE REVISIONS OOR RENOVATION ALUMNI 4 -Ο Π Ш Ω $\succ$ $\boldsymbol{\mathcal{S}}$ $\square$ > $\mathbf{R}$ Ľ Ц $\boldsymbol{\triangleleft}$ ADVANCEMEN $\triangleleft$ >Ш Γ ΤŪ Ζ $\mathcal{O}$ Ē Ν SNI $\simeq$

JOUNG

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BYU

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VOV

FACILITIES PLANNING

240 BRWB PROVO, UTAH 84602

PHONE: (801) 422-5504

FAX: (801) 422-0566

01.31.2025

DATE:

#### LEGEND

ELEVATIONS.

ELEVATIONS.

#### WALLS


- EXISTING WALL TO REMAIN
- = = EXISTING WALL DEMOLISH
- NEW MTL STUD WALL, RE: WALL TYPE

#### DOORS

- EXISTING DOOR TO REMAIN
  - EXISTING DOOR DEMOLISH

NEW DOOR

**KEY PLAN** 

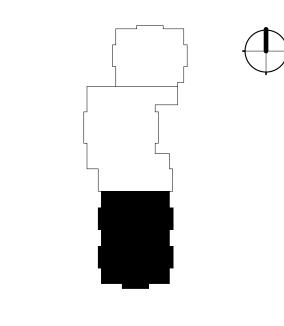

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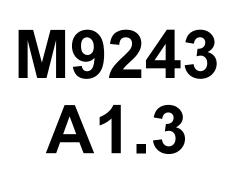
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WHEATL


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**NEW FLOOR PLAN** 







SCALE: 1/8" = 1'-0"

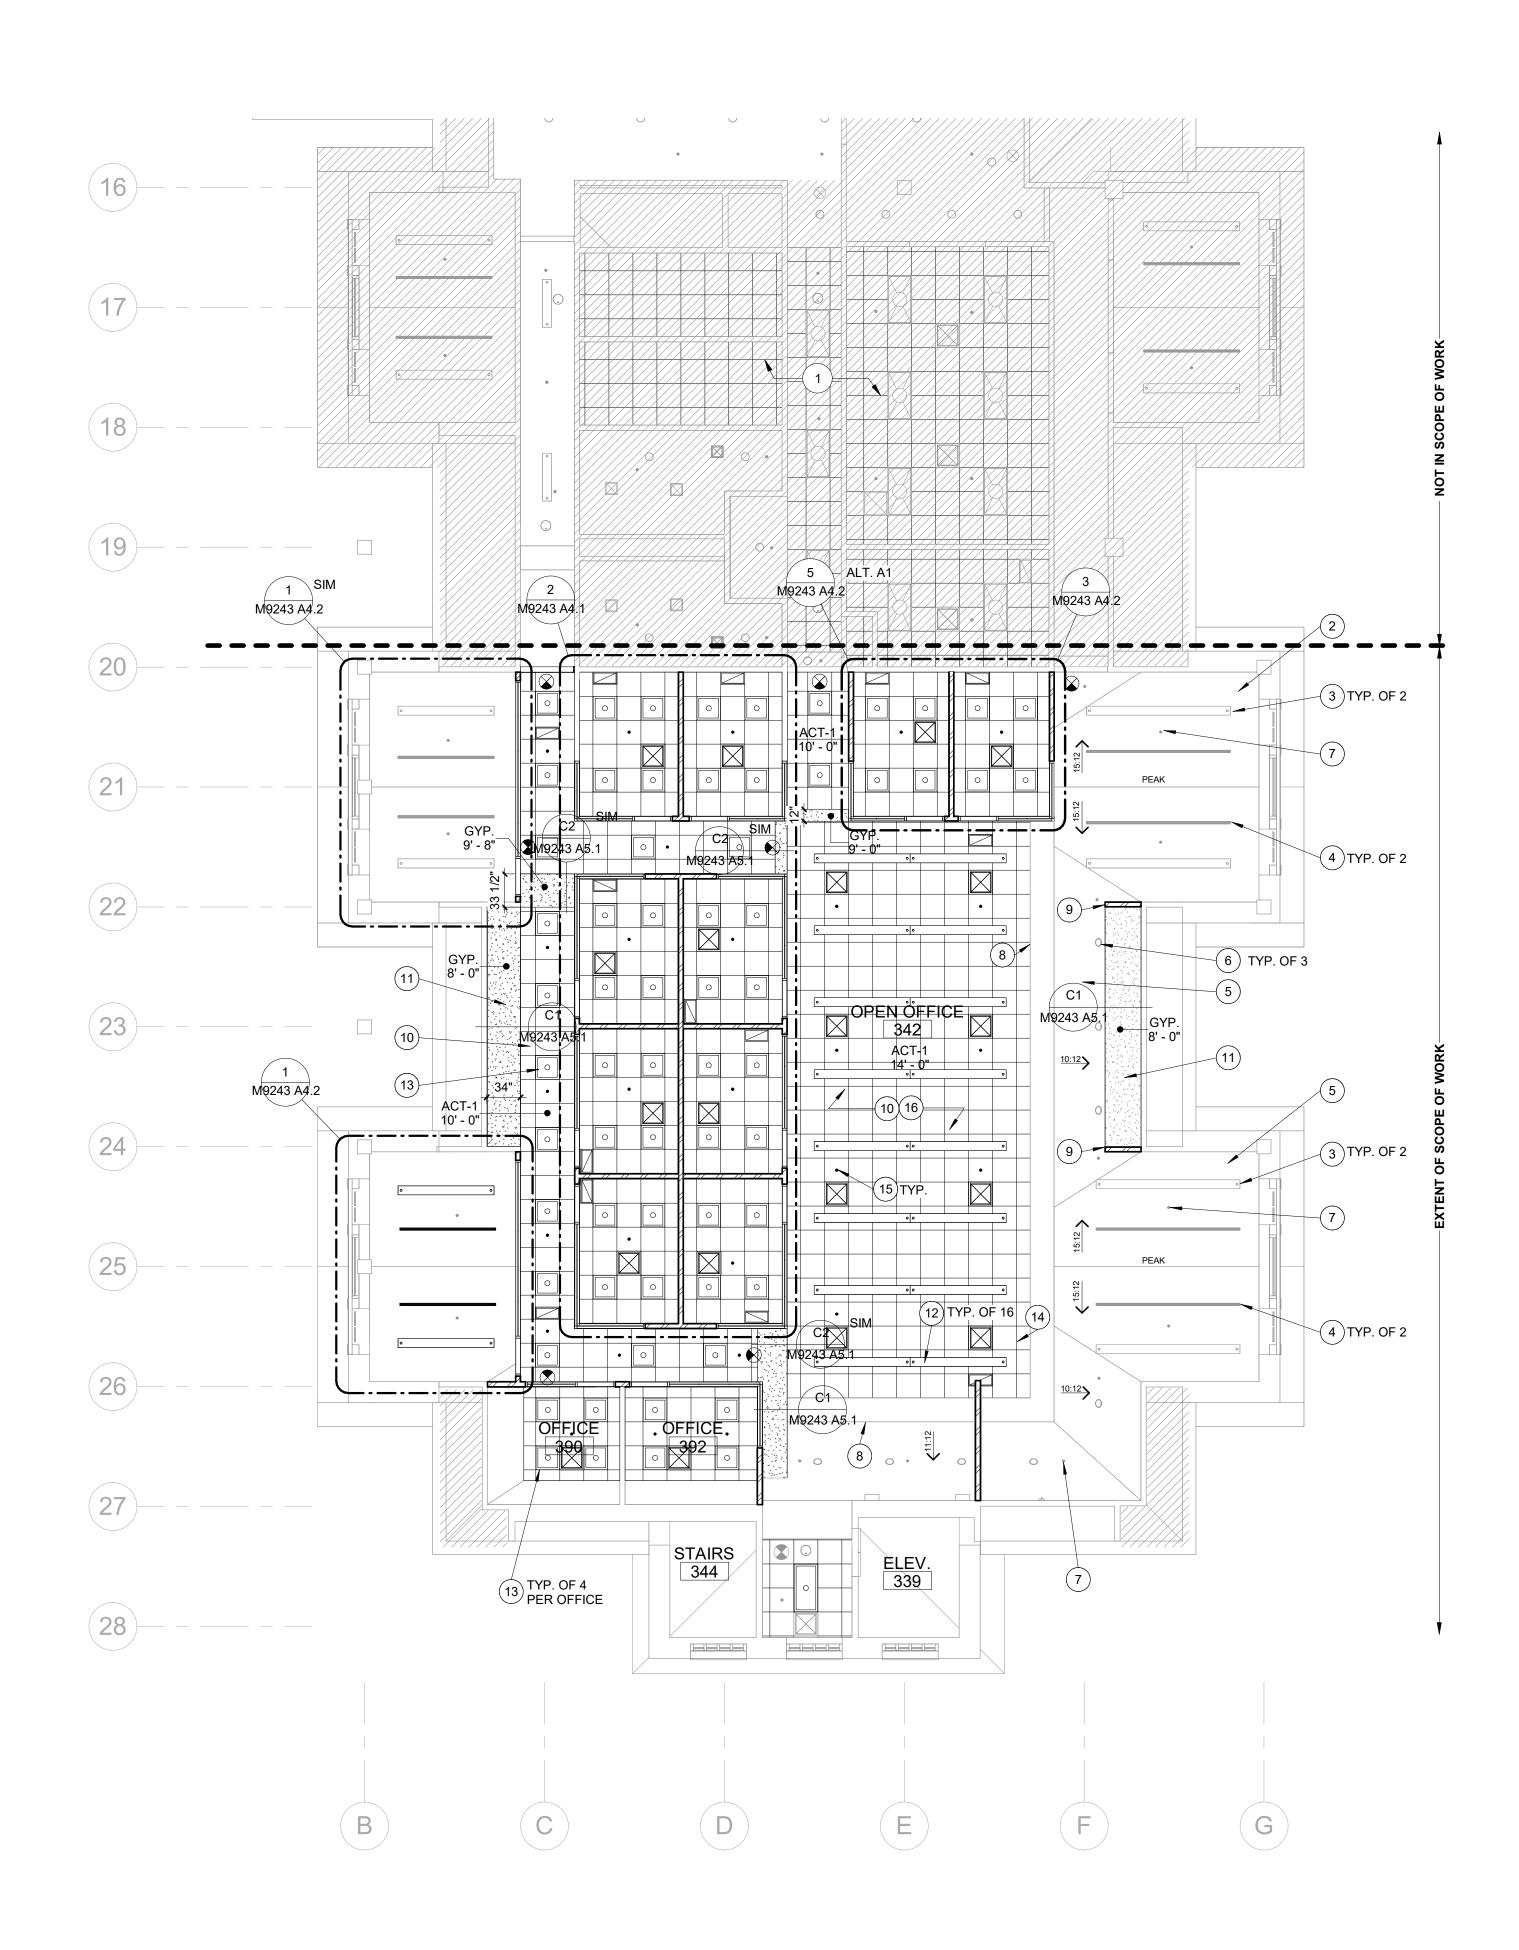


GENERAL NOTES	JOUNG U
<ol> <li>REFER TO RESPONSIBILITY MATRIX FOR A BREAKDOWN ON SCOPE OF WORK. GENERAL CONTRACTOR SHALL COORDINATE WITH OWNER FOR ALL ITEMS OUTSIDE THEIR SCOPE.</li> <li>ACOUSTICAL CEILINGS ARE TO BE INSTALLED WITH SEISMIC REINFORCEMENT BASED ON SEISMIC DESIGN CATEGORY TYPE 'D' REQUIREMENTS (ASTM C636 &amp; ASTM E580). INSTALL ALL REINFORCEMENT PER MANUFACTURER INSTALLATIONS INSTRUCTIONS.</li> <li>COMPOSITE REFLECTED ARCHITECTURAL CEILING PLAN SHOWN FOR COORDINATION. REFER TO MECHANICL AND ELECTRICAL DRAWING FOR FIXTURE AND DEVICE INFORMATION.</li> <li>CONTRACTOR TO COORDINATE WITH OWNER ON REROUTING AND INSTALLATION OF ALL COMMUNICATION DEVICES TO BE INSTALLED OUTSIDE THE CONTRACTORS SCOPE OF WORK.</li> </ol>	FOUNGUL         FOUNDED         FOUNDED         BYU         BYU
<b>REFERENCE NOTES</b> 1 DIAGONAL HATCH REGIONS INDICATE AREA	STRUCTURAL: UTILITIES DIR:
<ul> <li>NOT IN SCOPE OF WORK. TYPICAL.</li> <li>2 EXISTING SLOPED GYP. BD CEILING (DORMER CONDITION) TO REMAIN. PROTECT AS REQ'D.</li> <li>3 EXISTING LINEAR PENDANT LIGHT FIXTURE TO REMAIN, RE: ELECTRICAL.</li> </ul>	PLANNING DIR: CLIENT APPROVAL DATE
<ol> <li>EXISTING LINEAR DIFFUSER TO REMAIN. PROTECT AS REQUIRED. RE: MECHANICAL.</li> <li>EXISTING SLOPED GYP. BD CEILING (STANDARD CONDITION) TO REMAIN. PROTECT AS REQ'D.</li> </ol>	DEVISIONS
6 EXISTING RECESSED CAN LIGHT FIXTURE TO BE REMOVED AND REPLACED WITH NEW RECESSED LED FIXTURE. RE: ELECTRICAL	REVISIONS
PLANS. 7 EXISTING CONCEALED FIRE SPRINKLER TO REMAIN IN PLACE. PROTECT AS REQUIRED. RE:	
PLUMBING.         8       EXISTING GYP. BOARD CEILING SOFFIT TO REMAIN. PATCH, REPAIR, AND PAINT ANY AREA THAT RECEIVE DAMAGE AS A RESULT OF CONSTRUCTION ACTIVITIES.         9       NEW MTL STUD FRAMED WALL (RE WALL TYPE ASSEMBLY). EXTEND AND SECURE WALL UP TO 12" ABOVE HIGHEST CEILING.         10       NEW 2' X 2' CEILING AND GRID SYSTEM; MODIFY ELECTRICAL AND MECHANICAL DEVICES AND EQUIPMENT AS INDICATED ON PLANS.         11       PROVIDE AND INSTALL NEW SUSPENDED GYP. BD. SOFFIT ON MTL STUD FRAMING.         12       RELOCATED EXISTING LINEAR LIGHT FIXTURE, TYPICAL. RE: ELECTRICAL.         13       PROVIDE NEW ELECTRICAL LED FLAT PANEL LIGHT FIXTURES. RE: ELECTRICAL.         14       NEW DIFFUSER/GRILLE, RE: MECHANICAL.         15       MODIFY/ADJUST EXISTING SPRINKLER FLEX HEAD AS REQUIRED TO RELOCATE SPRINKLER HEAD TO NEW LOCATION.         16       ALT A2 - MODIFY AND LOWER EXISTING MECHANICAL VAV'S TO 18" ABOVE CEILING, RE: MECH. DRAWINGS.         LEEGEEND         CEILINGS         SLOPED GYP CEILING - DEMOLISH         I       EXISTING CEILING - TO REMAIN         I       NEW CEILING         I       NEW CEILING         I       NEW CEILING         I       PENDANT LIGHT FIXTURE - EXISTING TO REMAIN	B R I G H A M Y O U N G U N I V E R S I T Y WHEATLEY INSTITUTE - 3RD FLOOR RENOVATION ADVANCEMENT VP - ALUMNI GORDON B. HINCKLEY ALUMNIAND VISITORS CENTER
<ul> <li>PENDANT LIGHT FIXTURE - REINSTALLED</li> <li>LAY-IN LIGHT FIXTURE (SIZE VARIES) - DEMOLISH</li> <li>LAY-IN LIGHT FIXTURE (SIZE VARIES)</li> <li>MECHANICAL DIFFUSER/GRILLE</li> <li>LINEAR SLOT DIFFUSER - EXISTING</li> <li>LINEAR SLOT DIFFUSER - DEMOLISHED</li> <li>CONCEALED FIRE SPRINKLER HEAD</li> <li>EXIT SIGNAGE</li> </ul>	01/31/2025
◎ WIRELESS ACCESS POINT	
KEY PLAN	NEW REFLECTED CEILING PLAN
	WORK ORDER & SHEET NO.
	A1.4

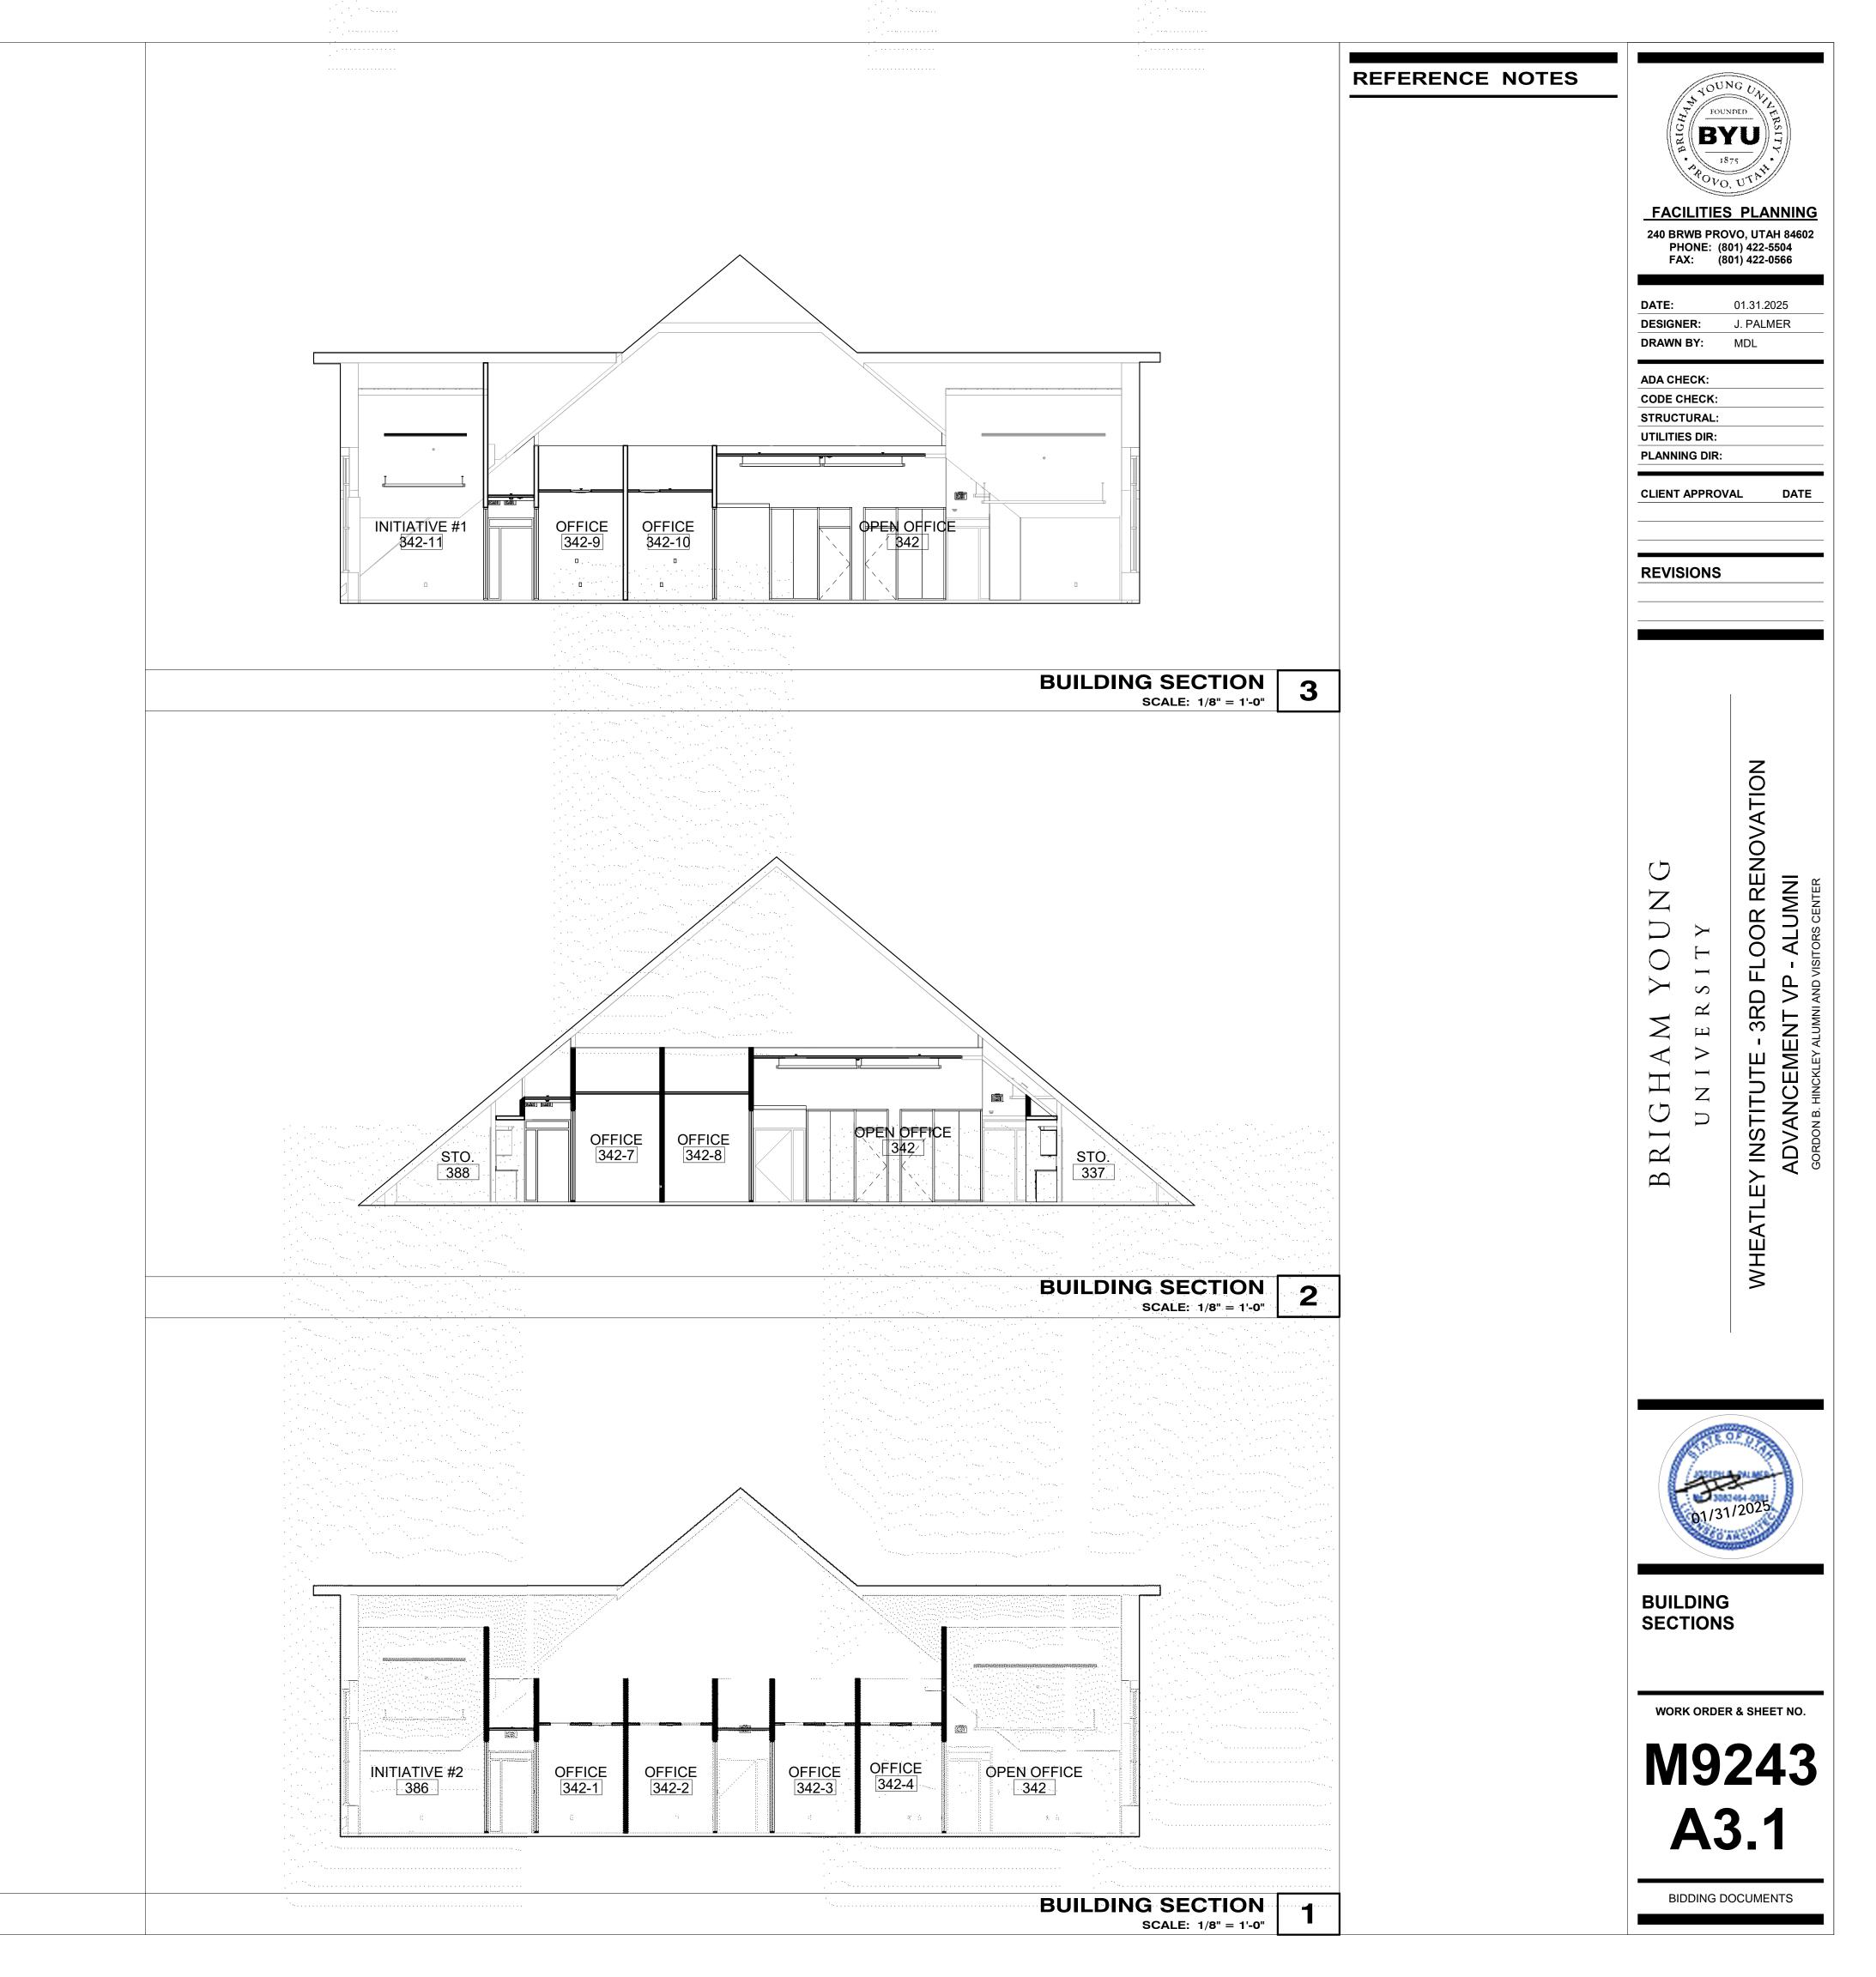


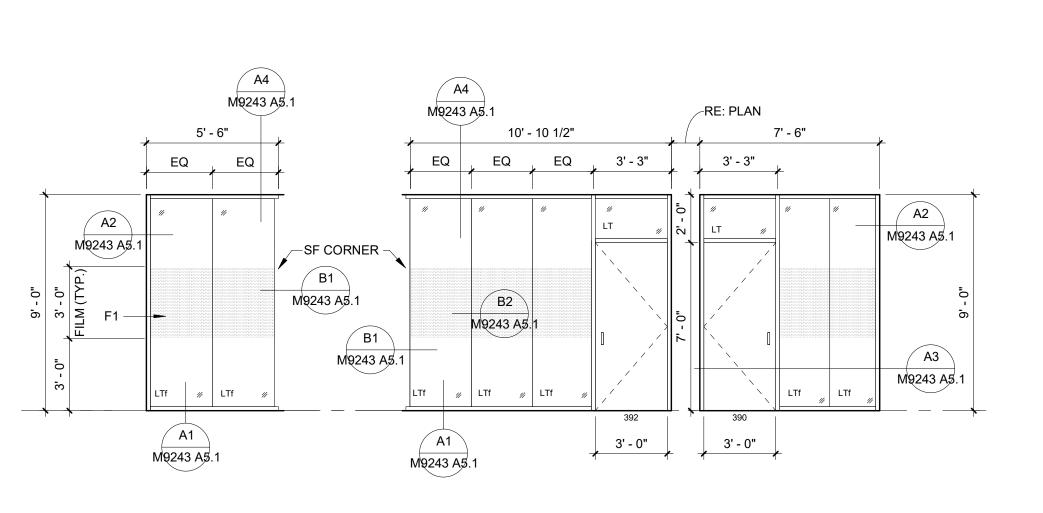


## GLASS TYPE D

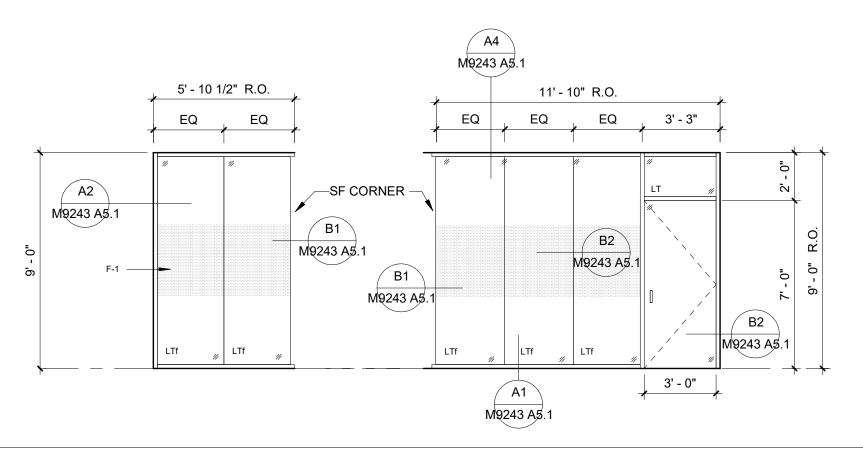


## GLASS TYPE C

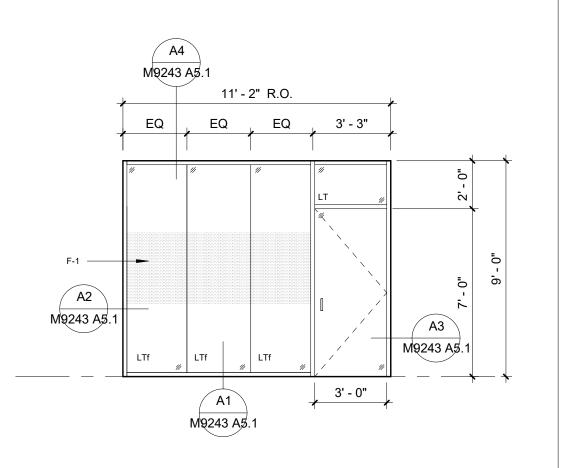



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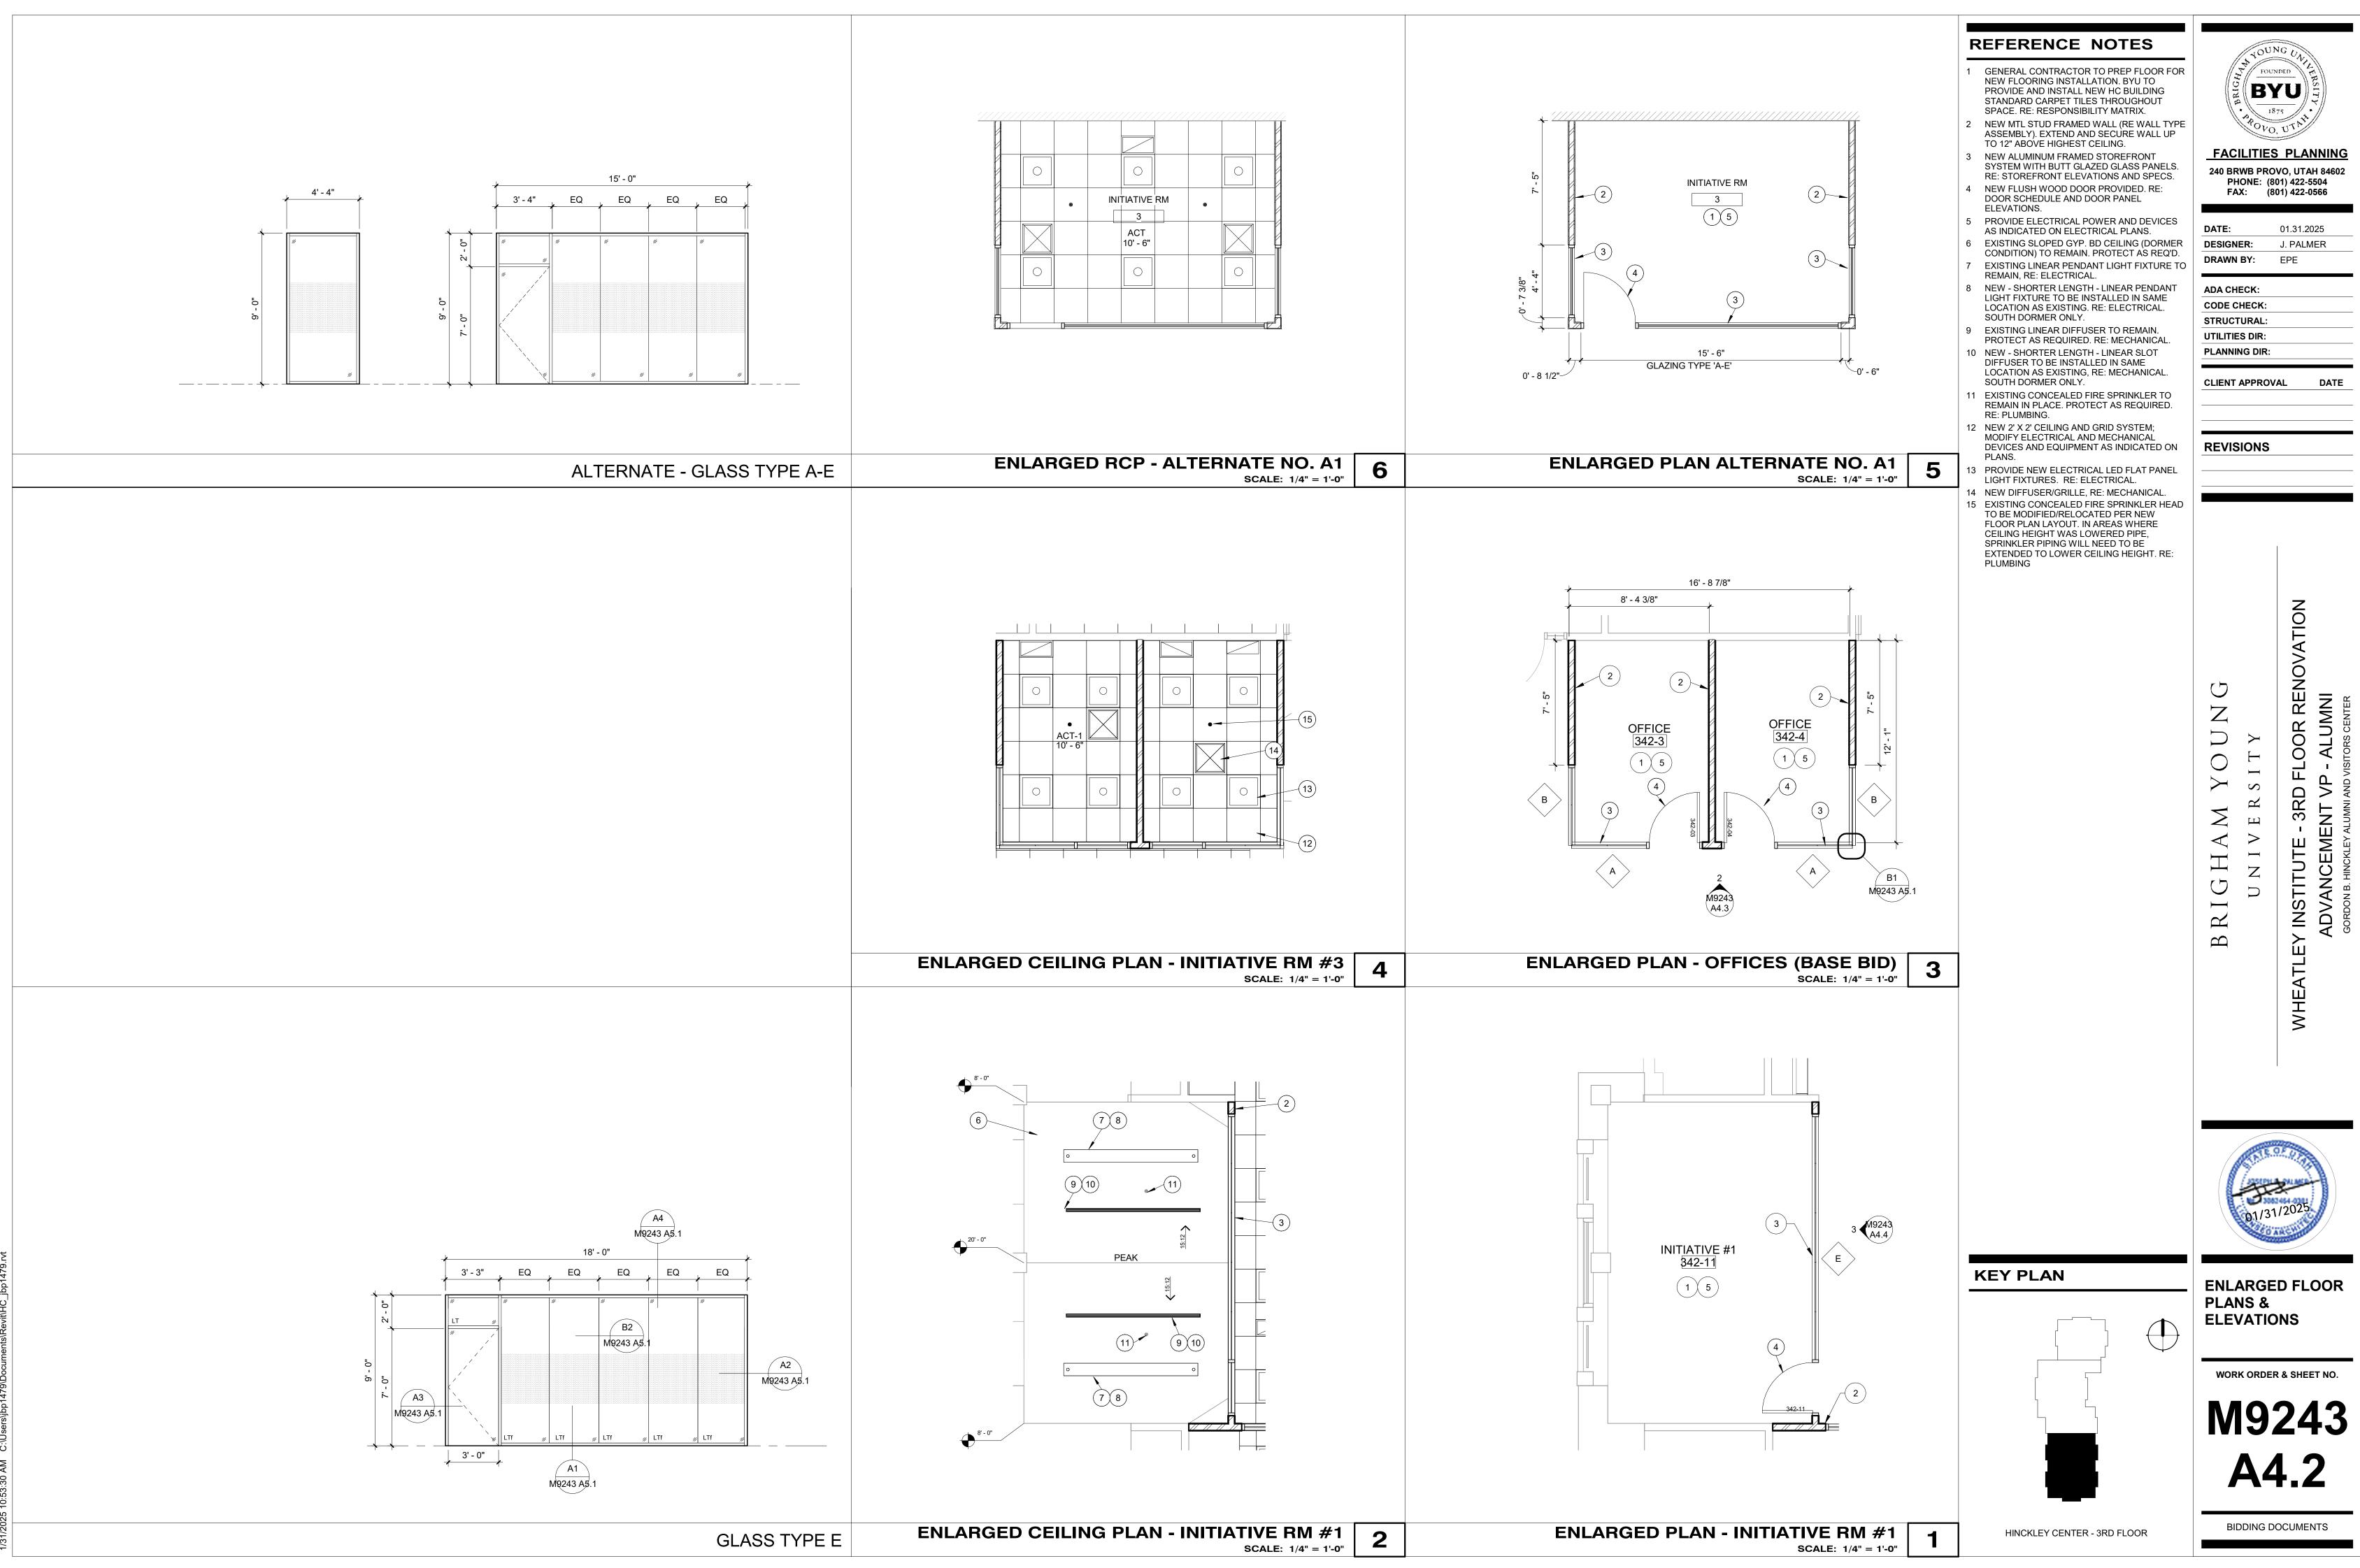


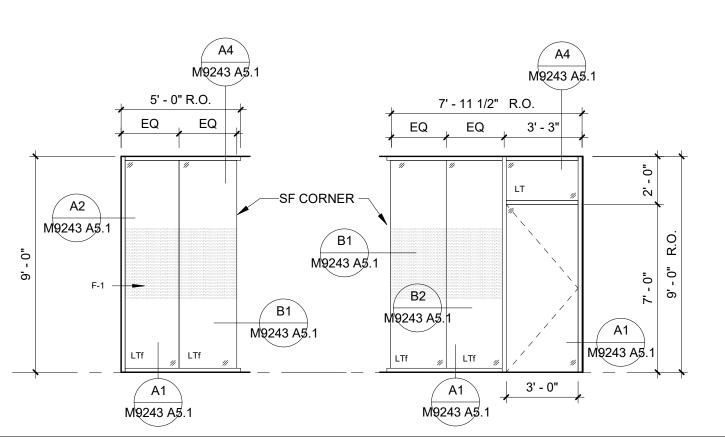
GLASS TYPE A




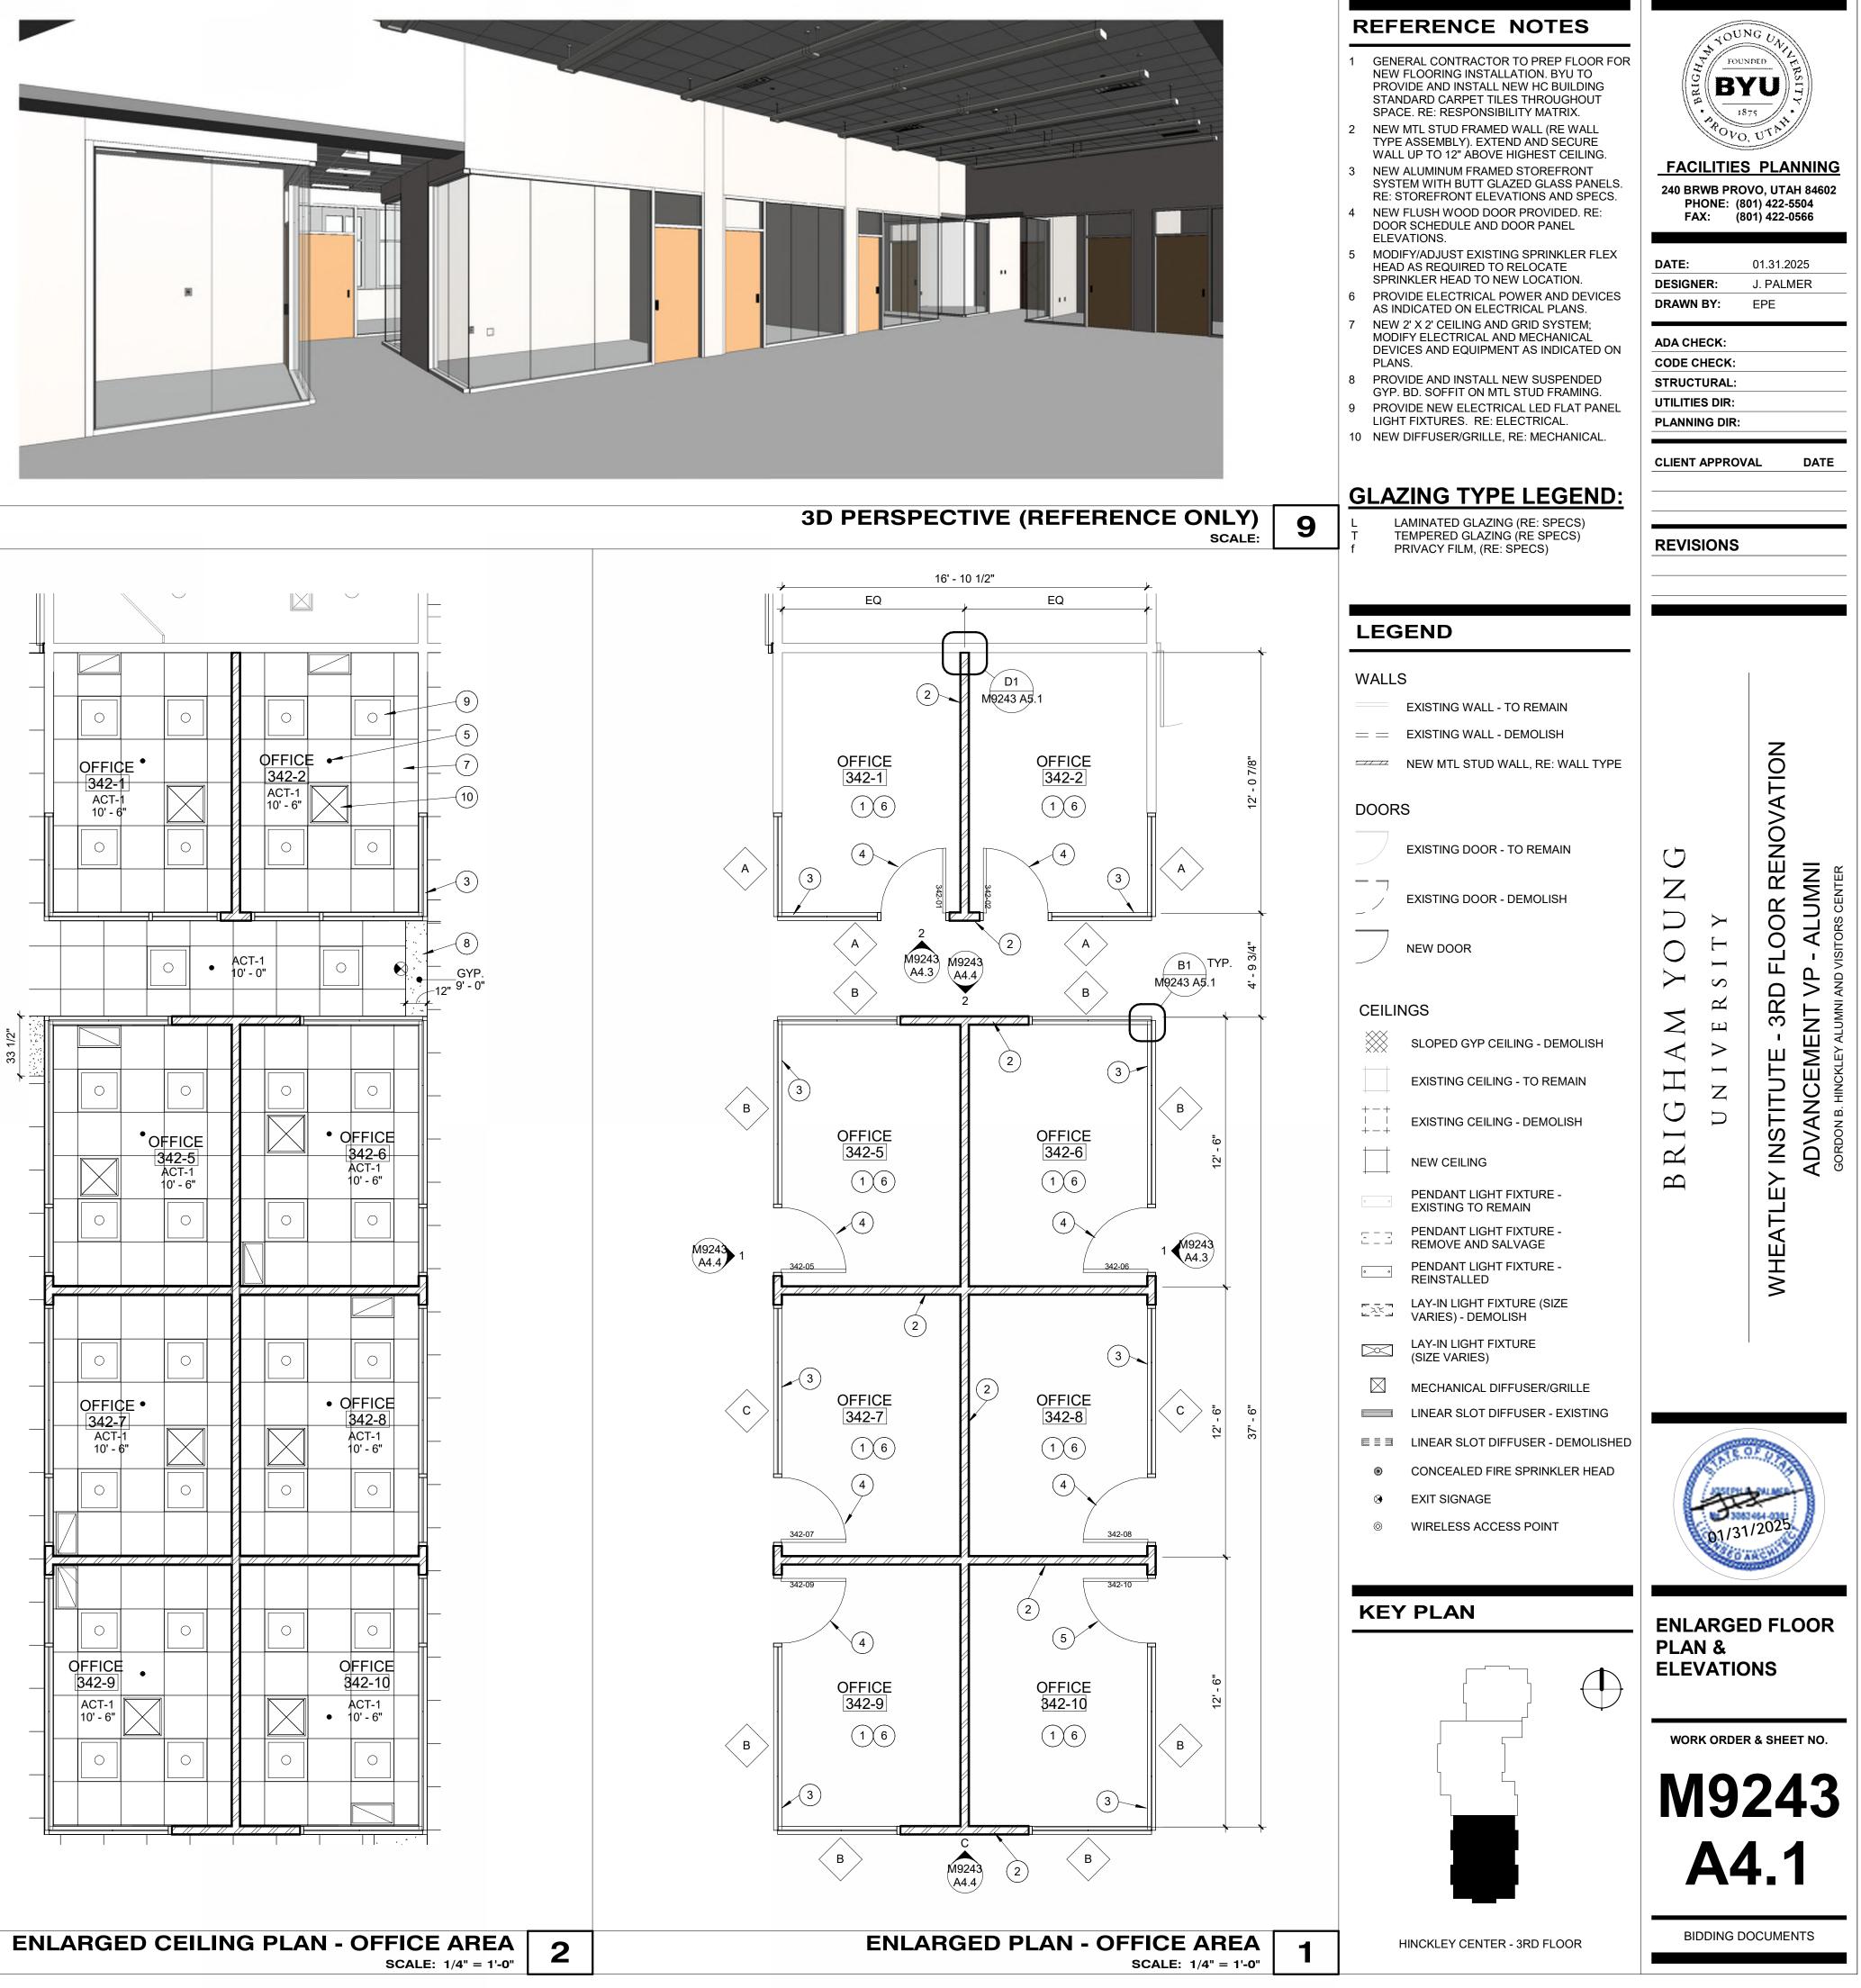


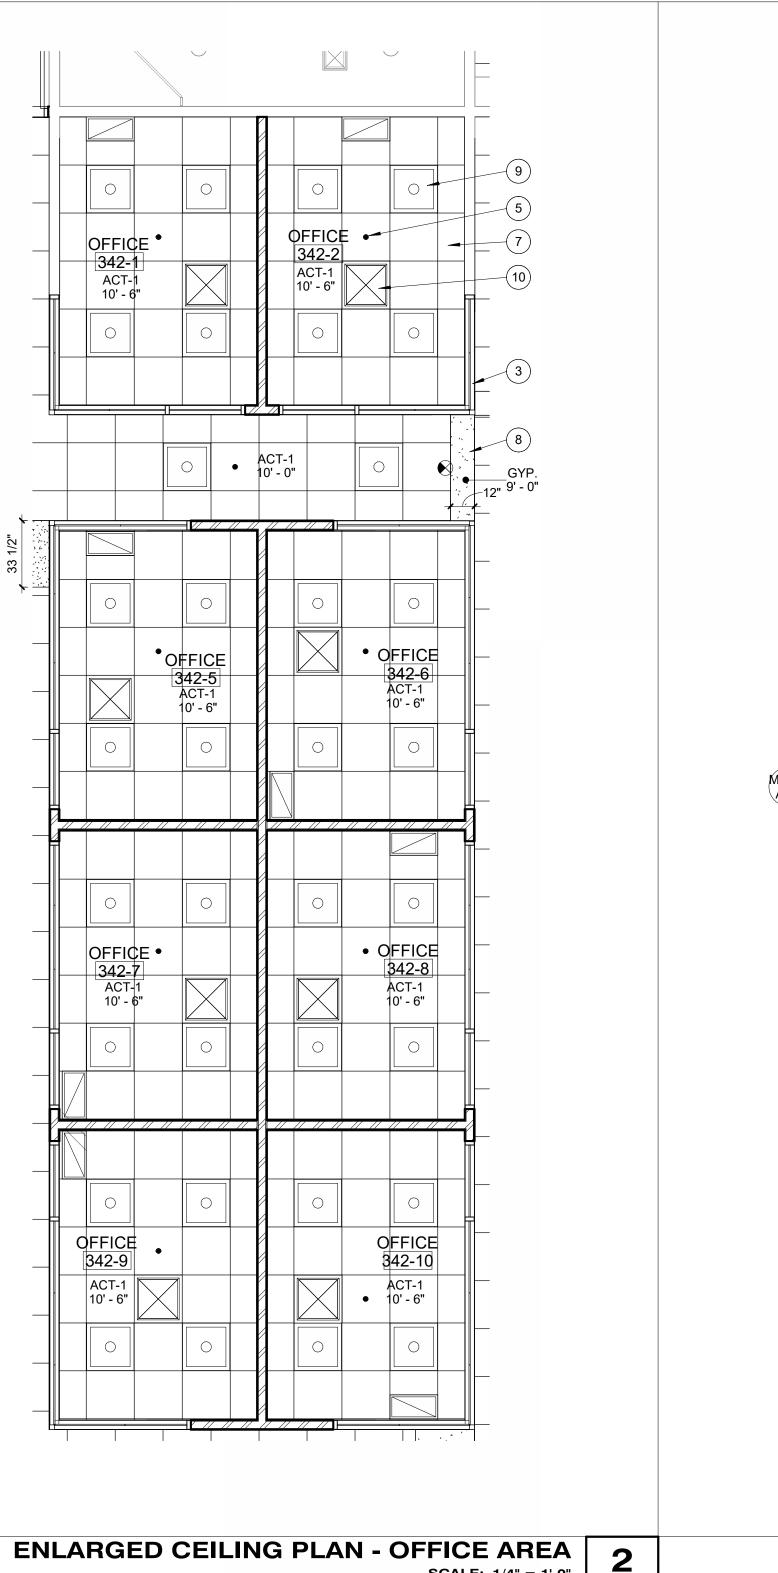


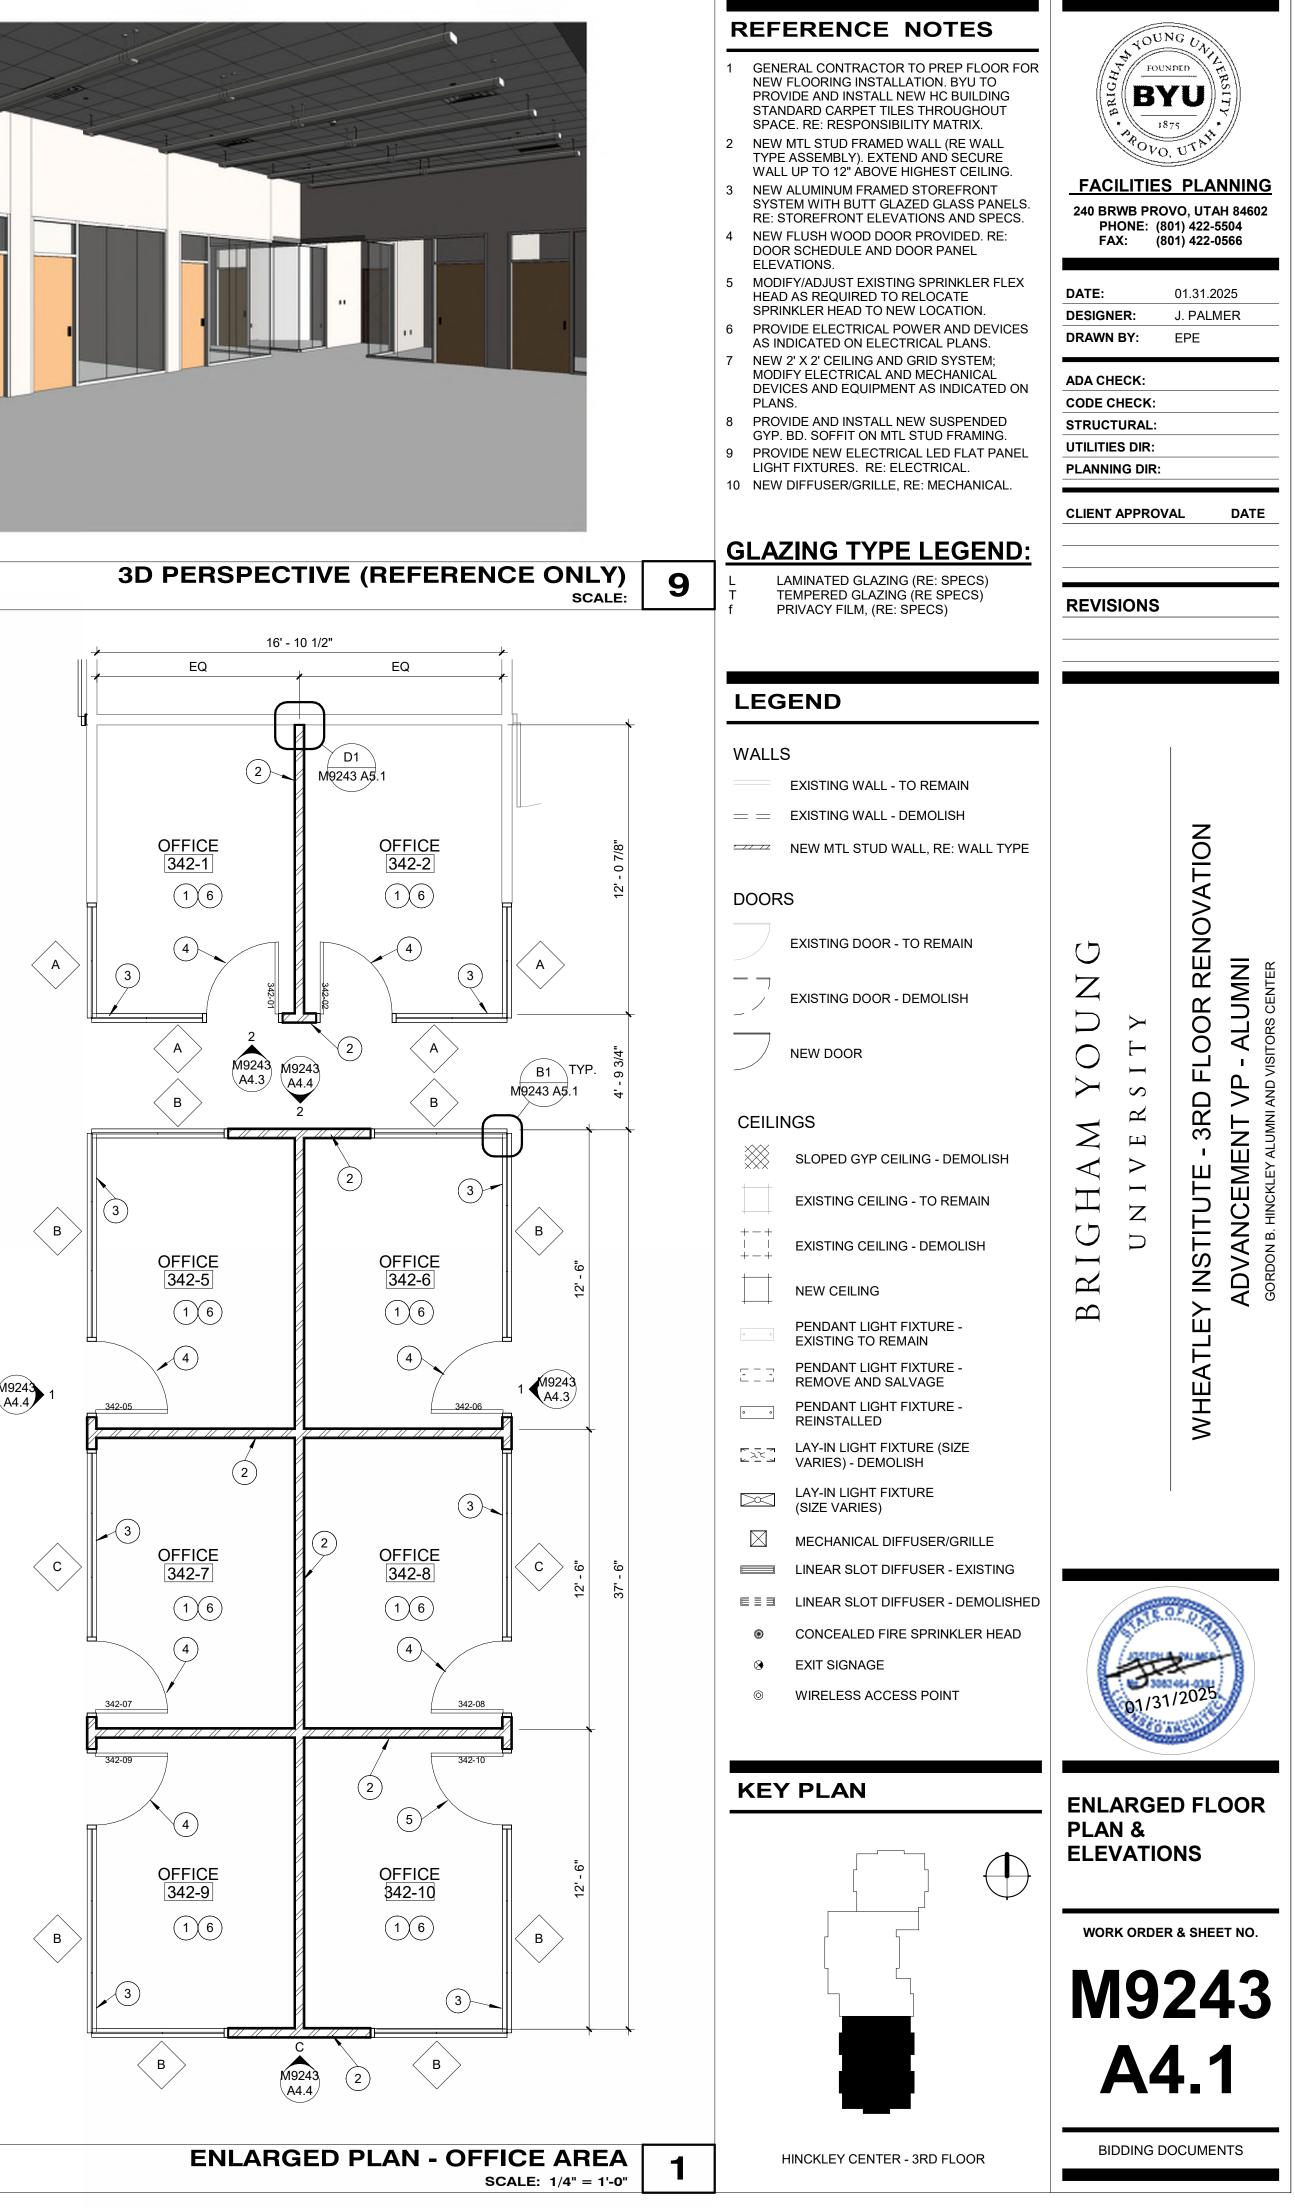


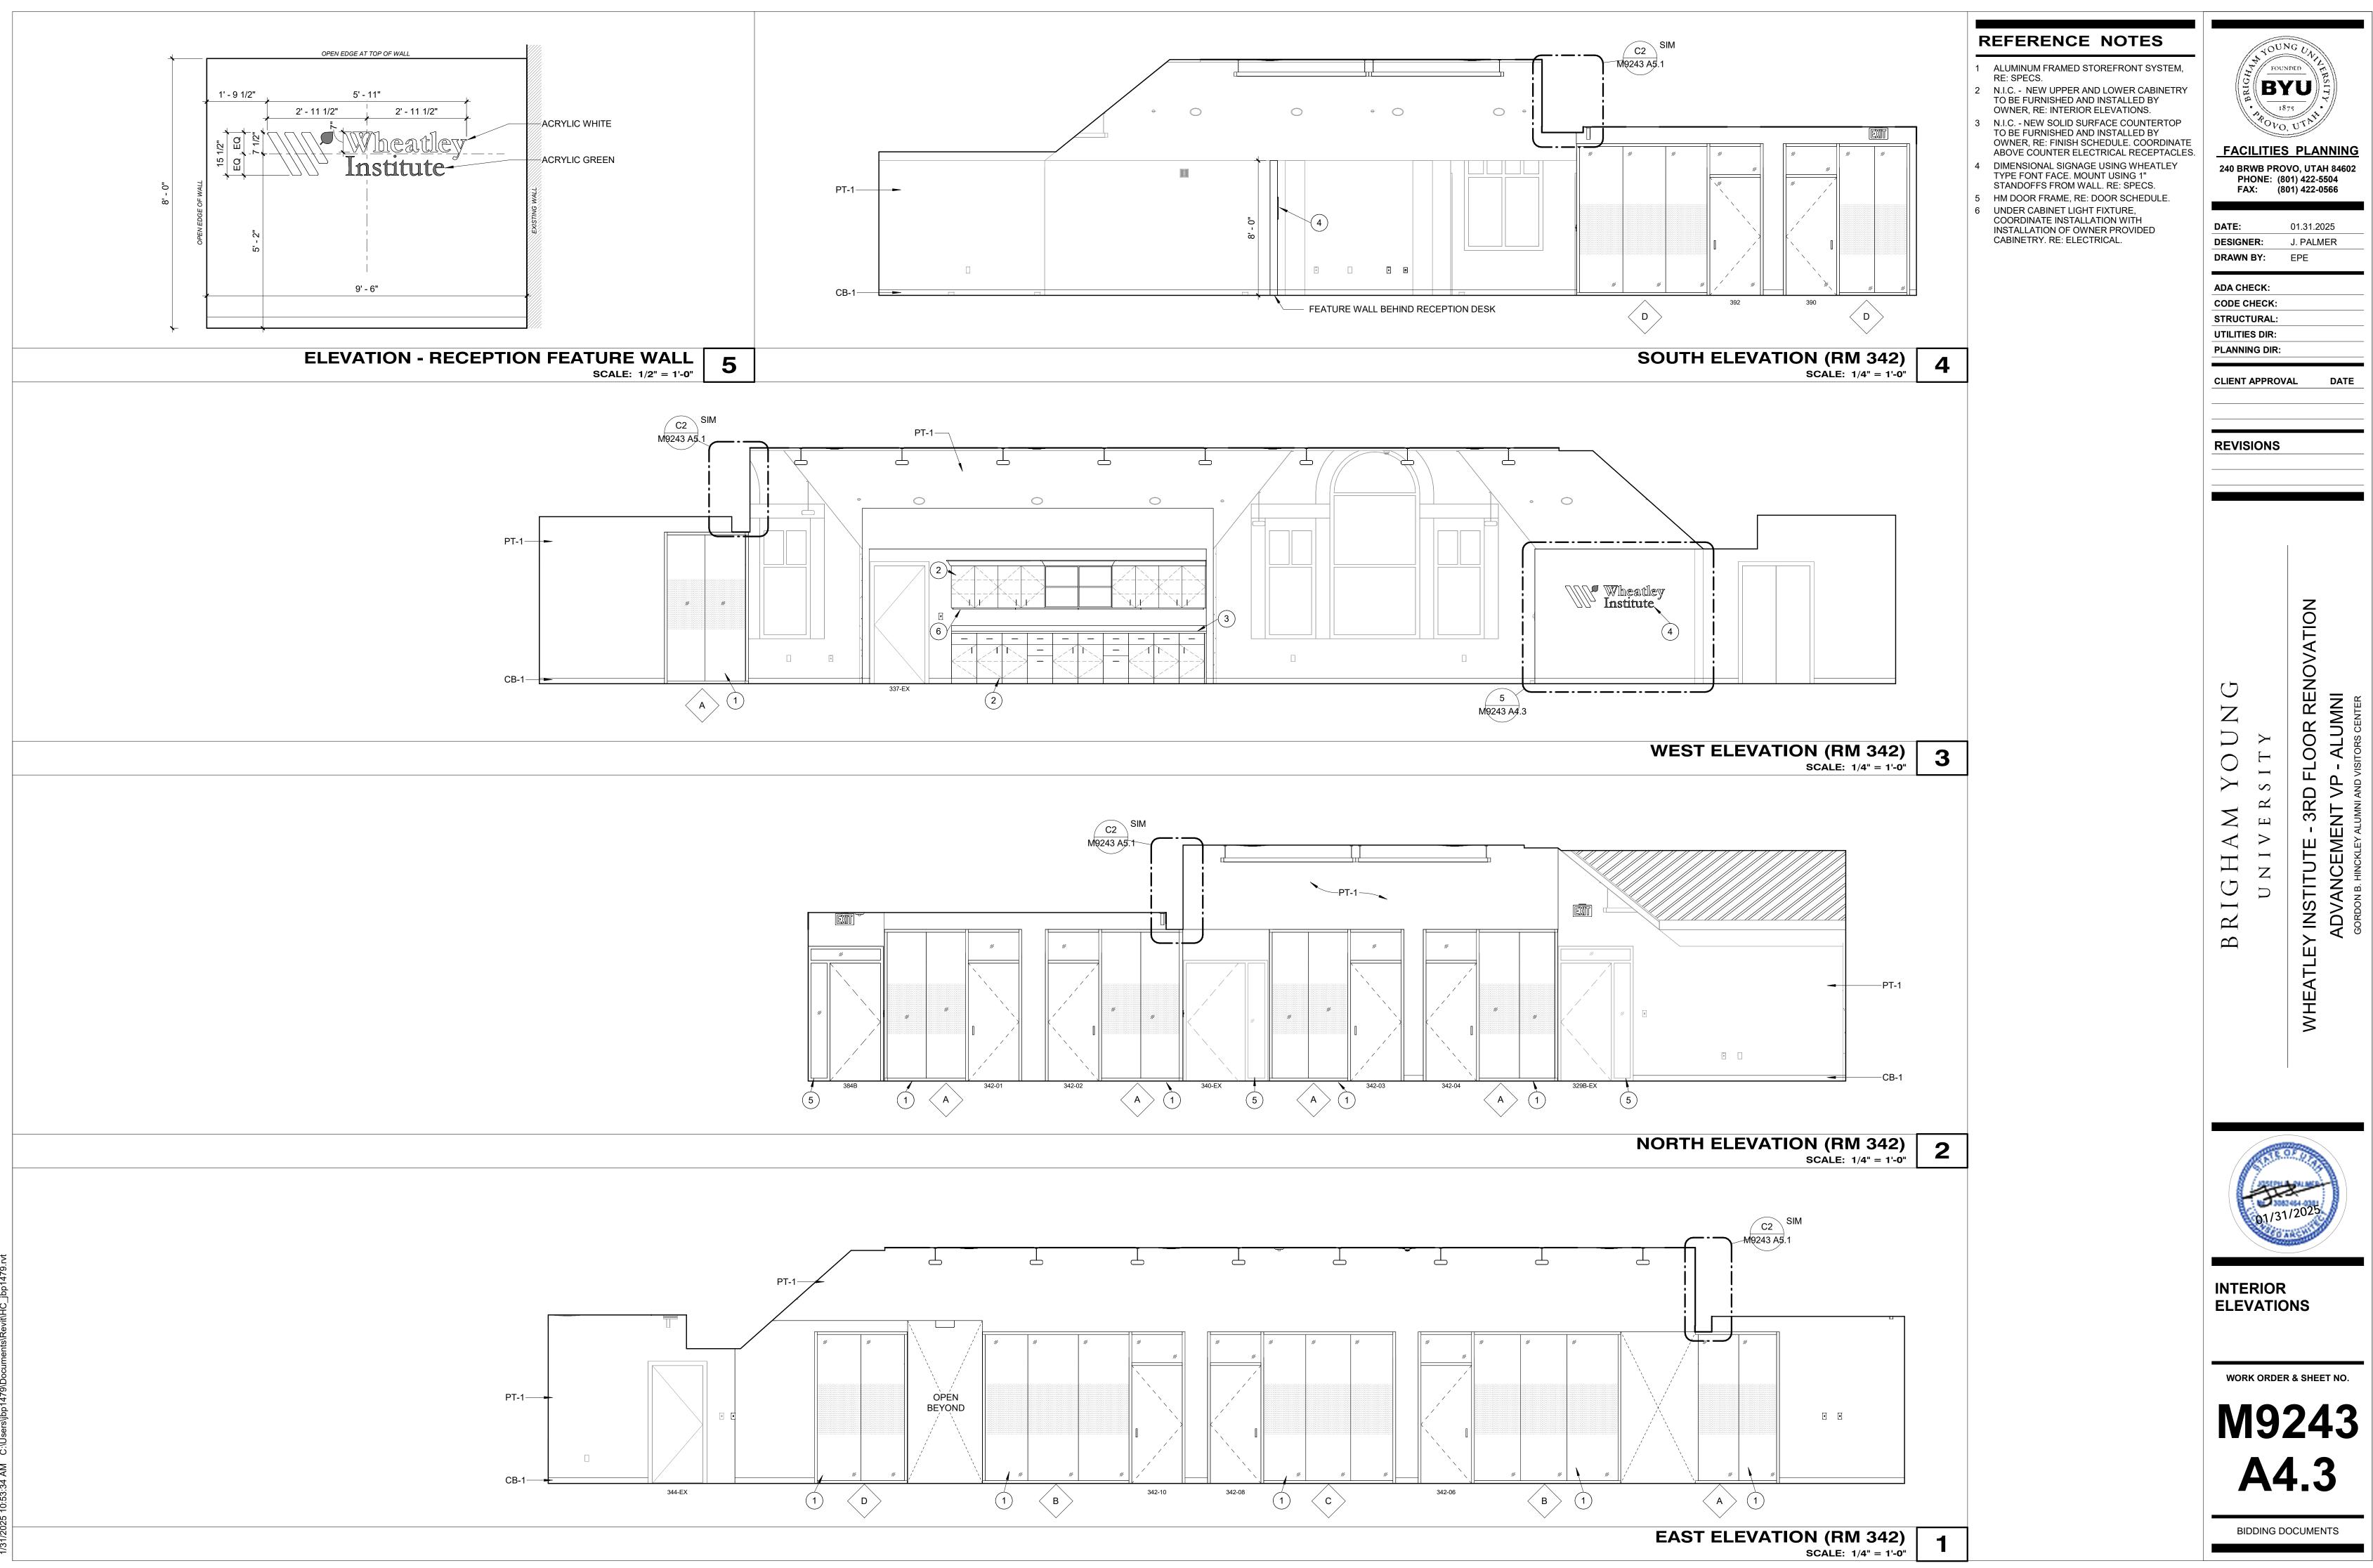


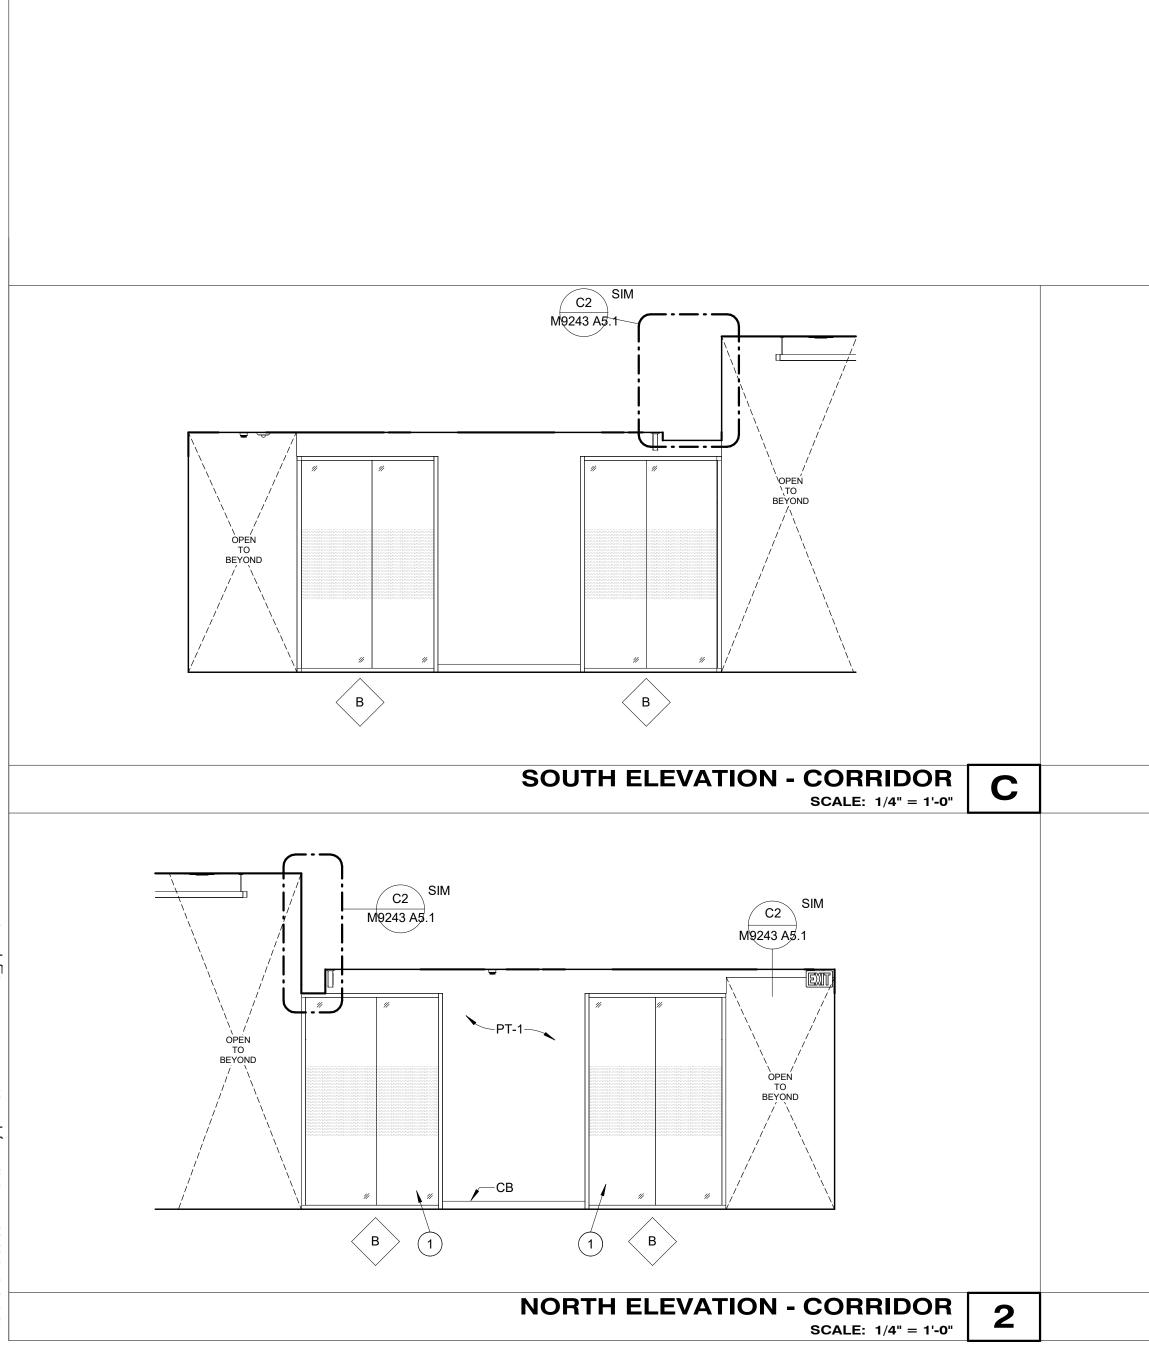

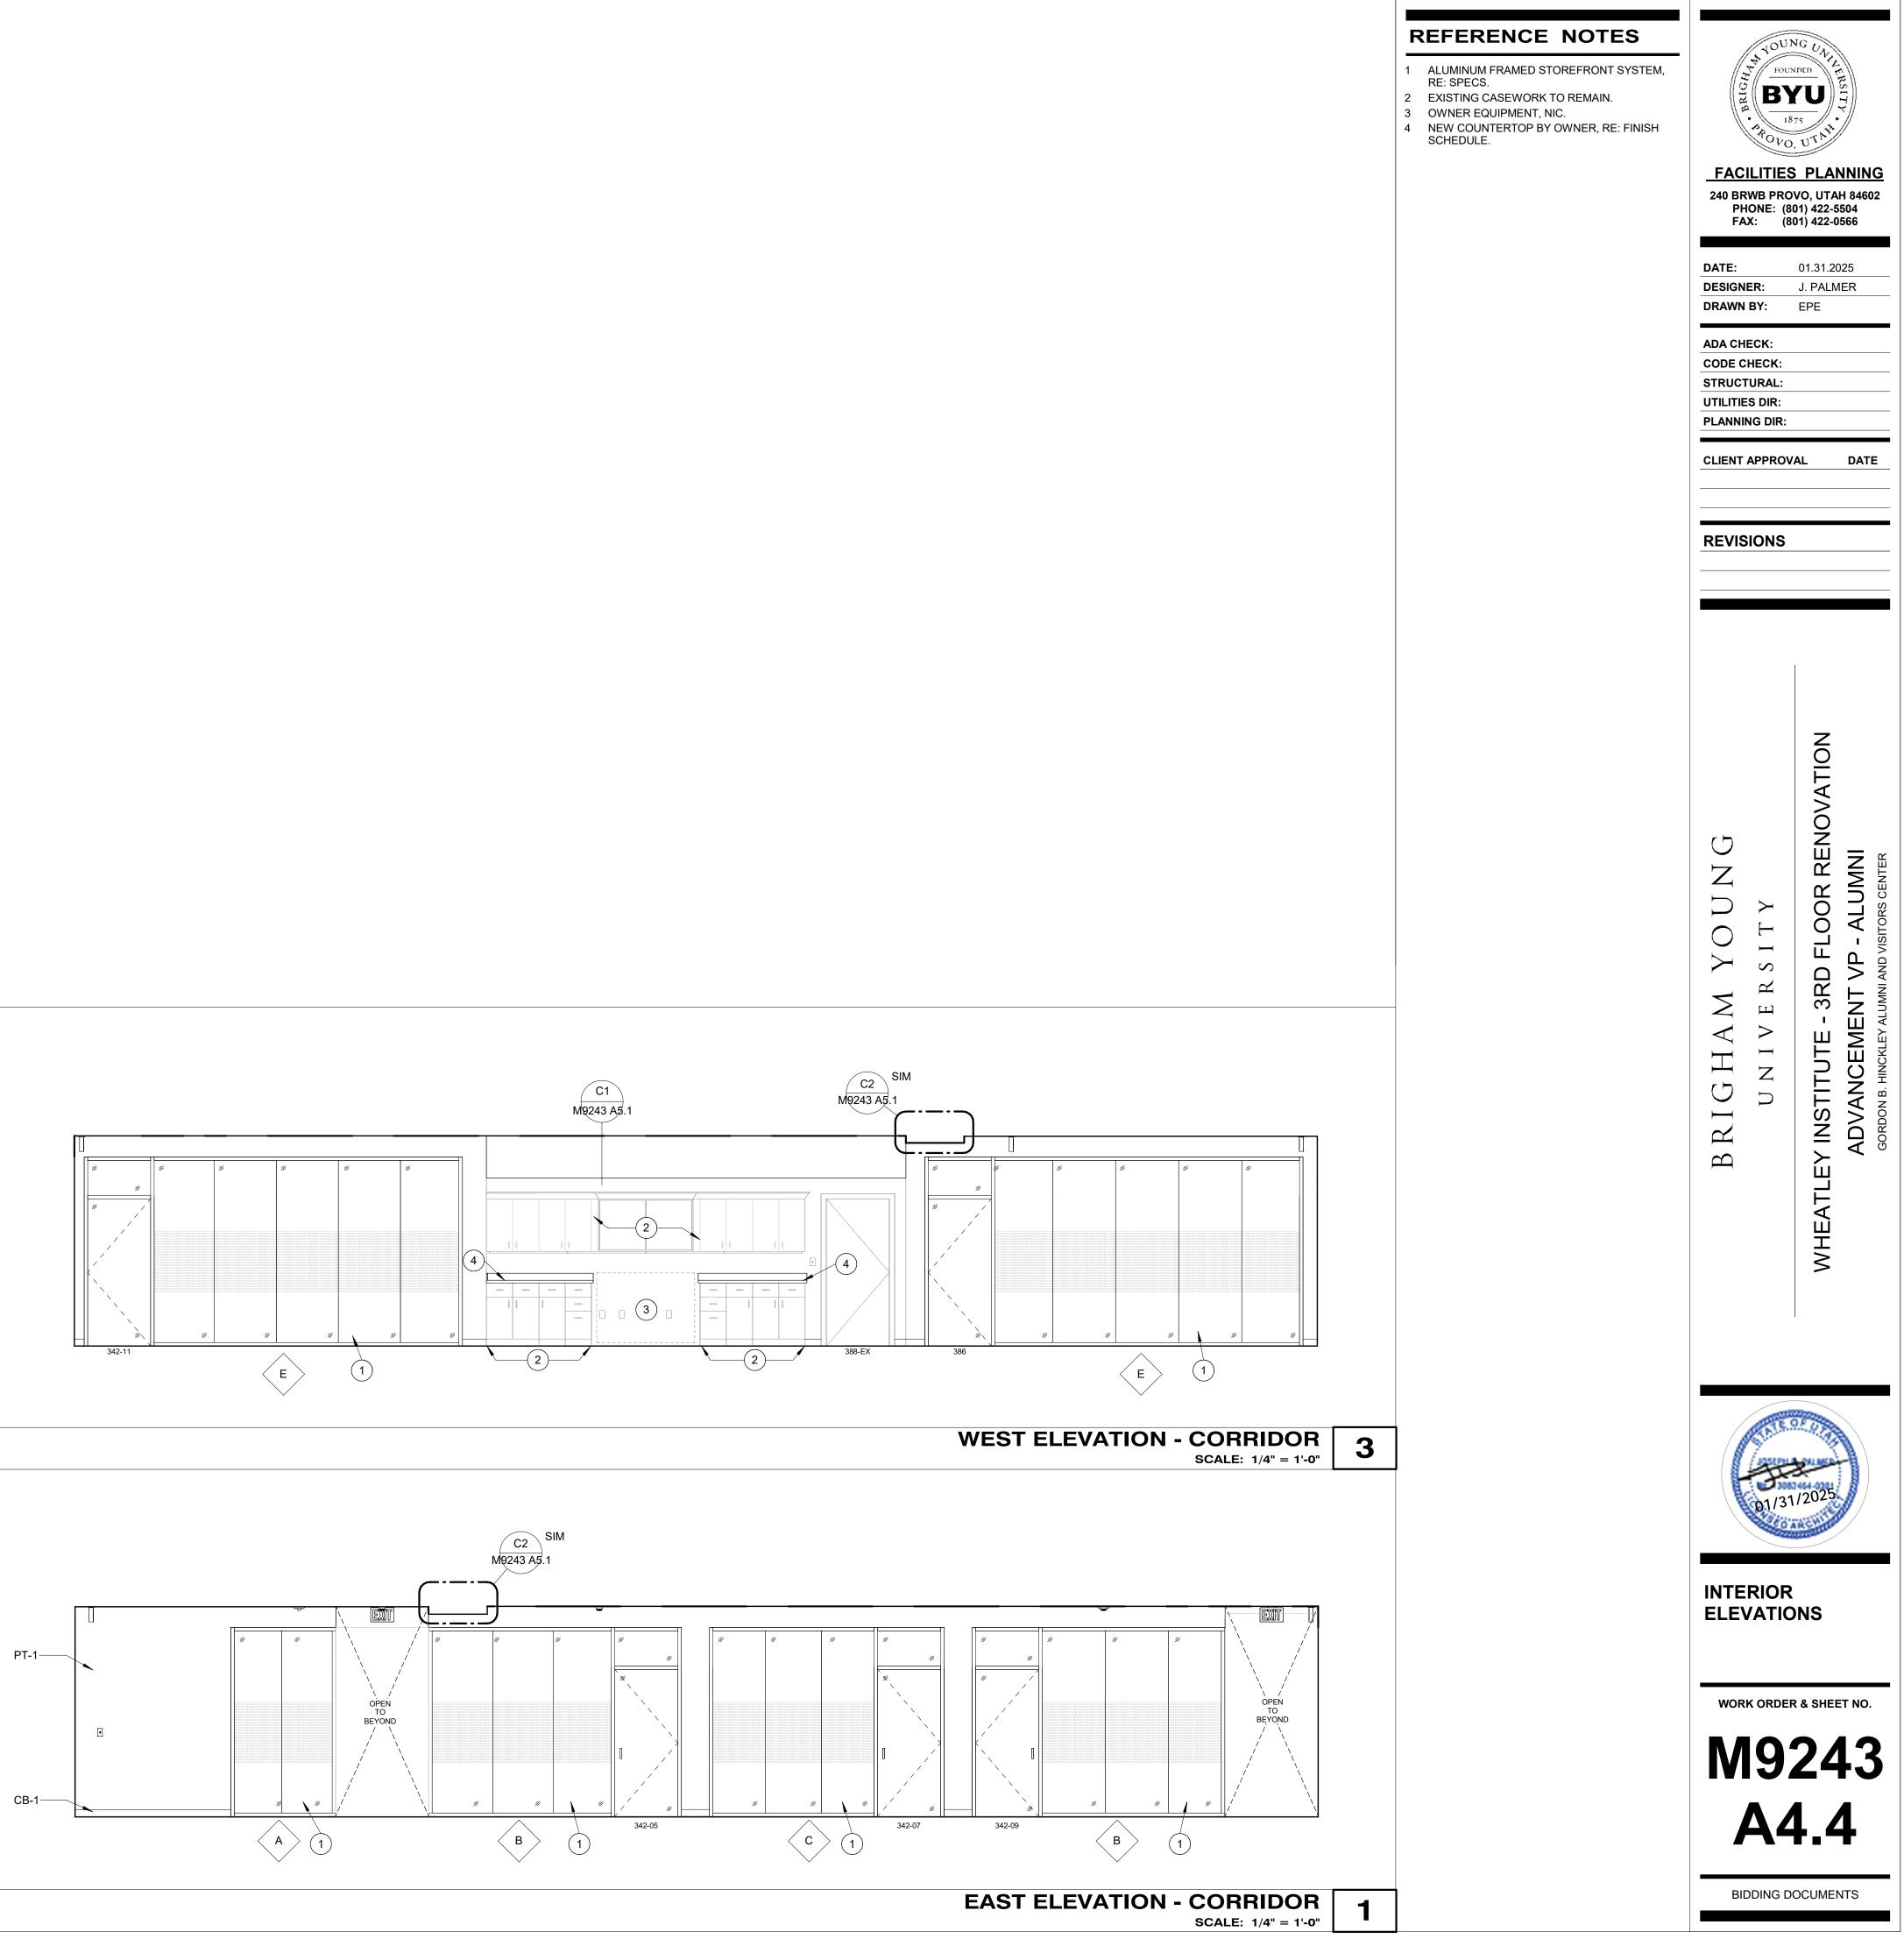

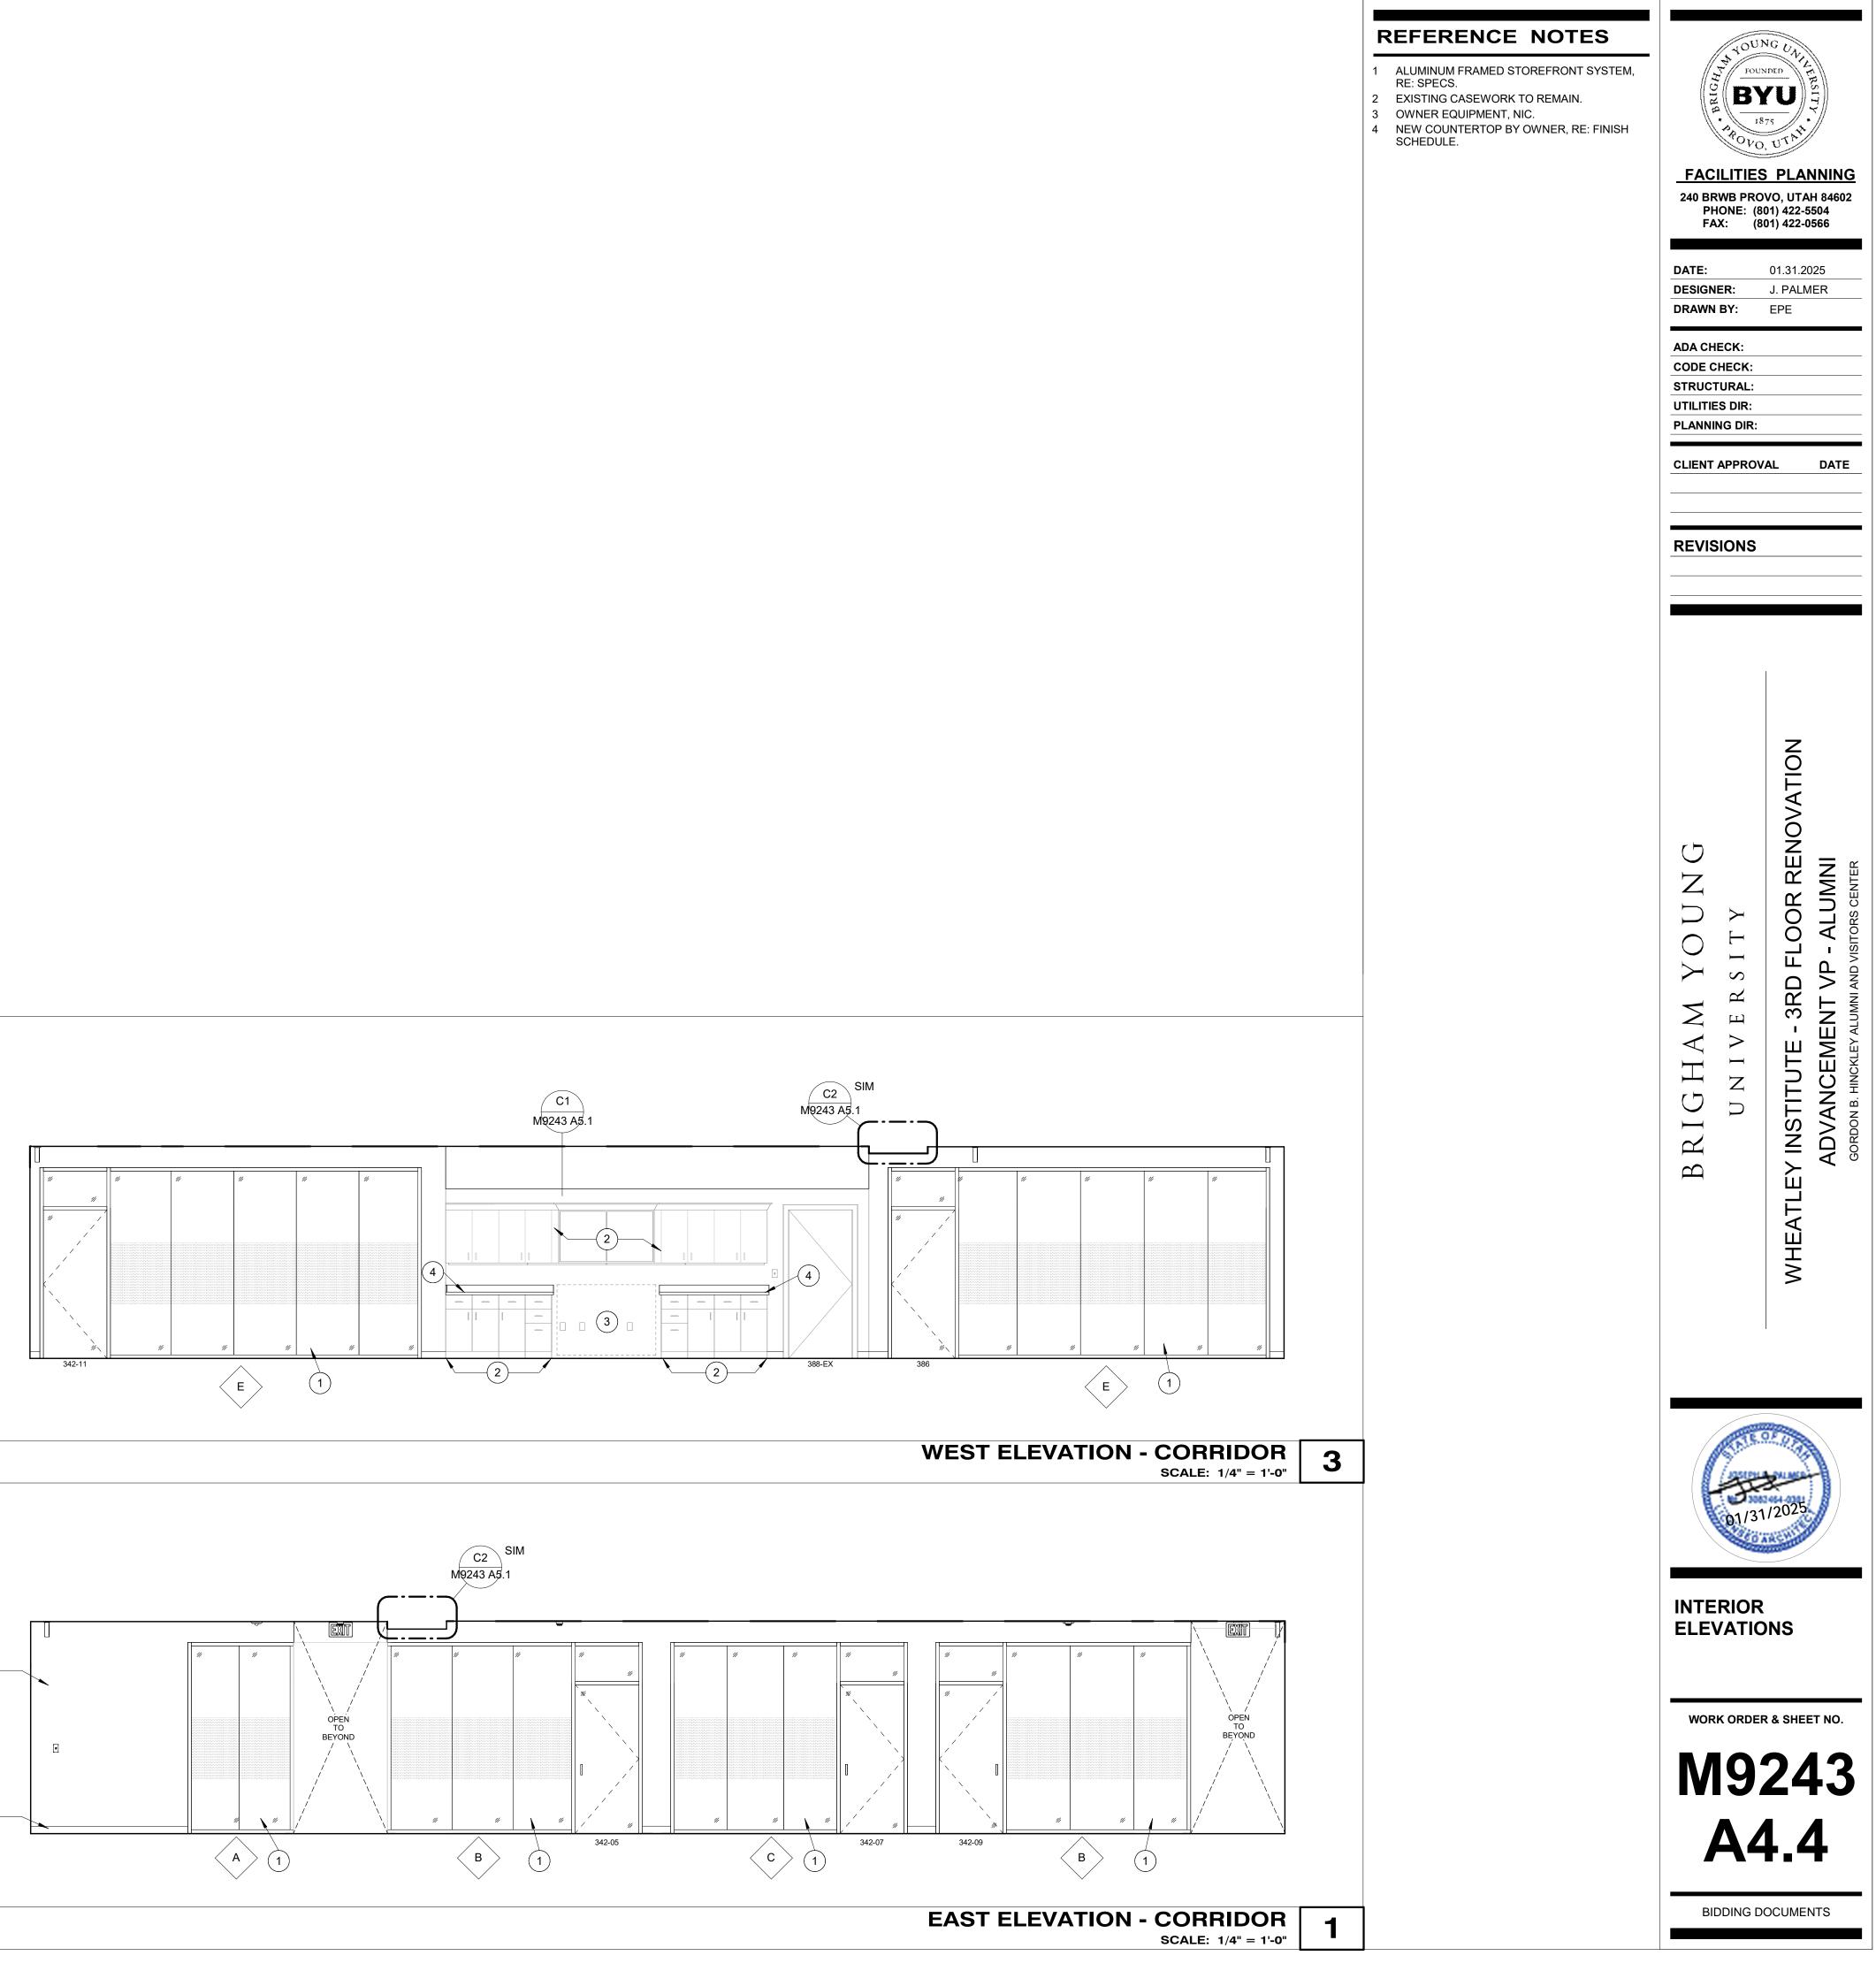

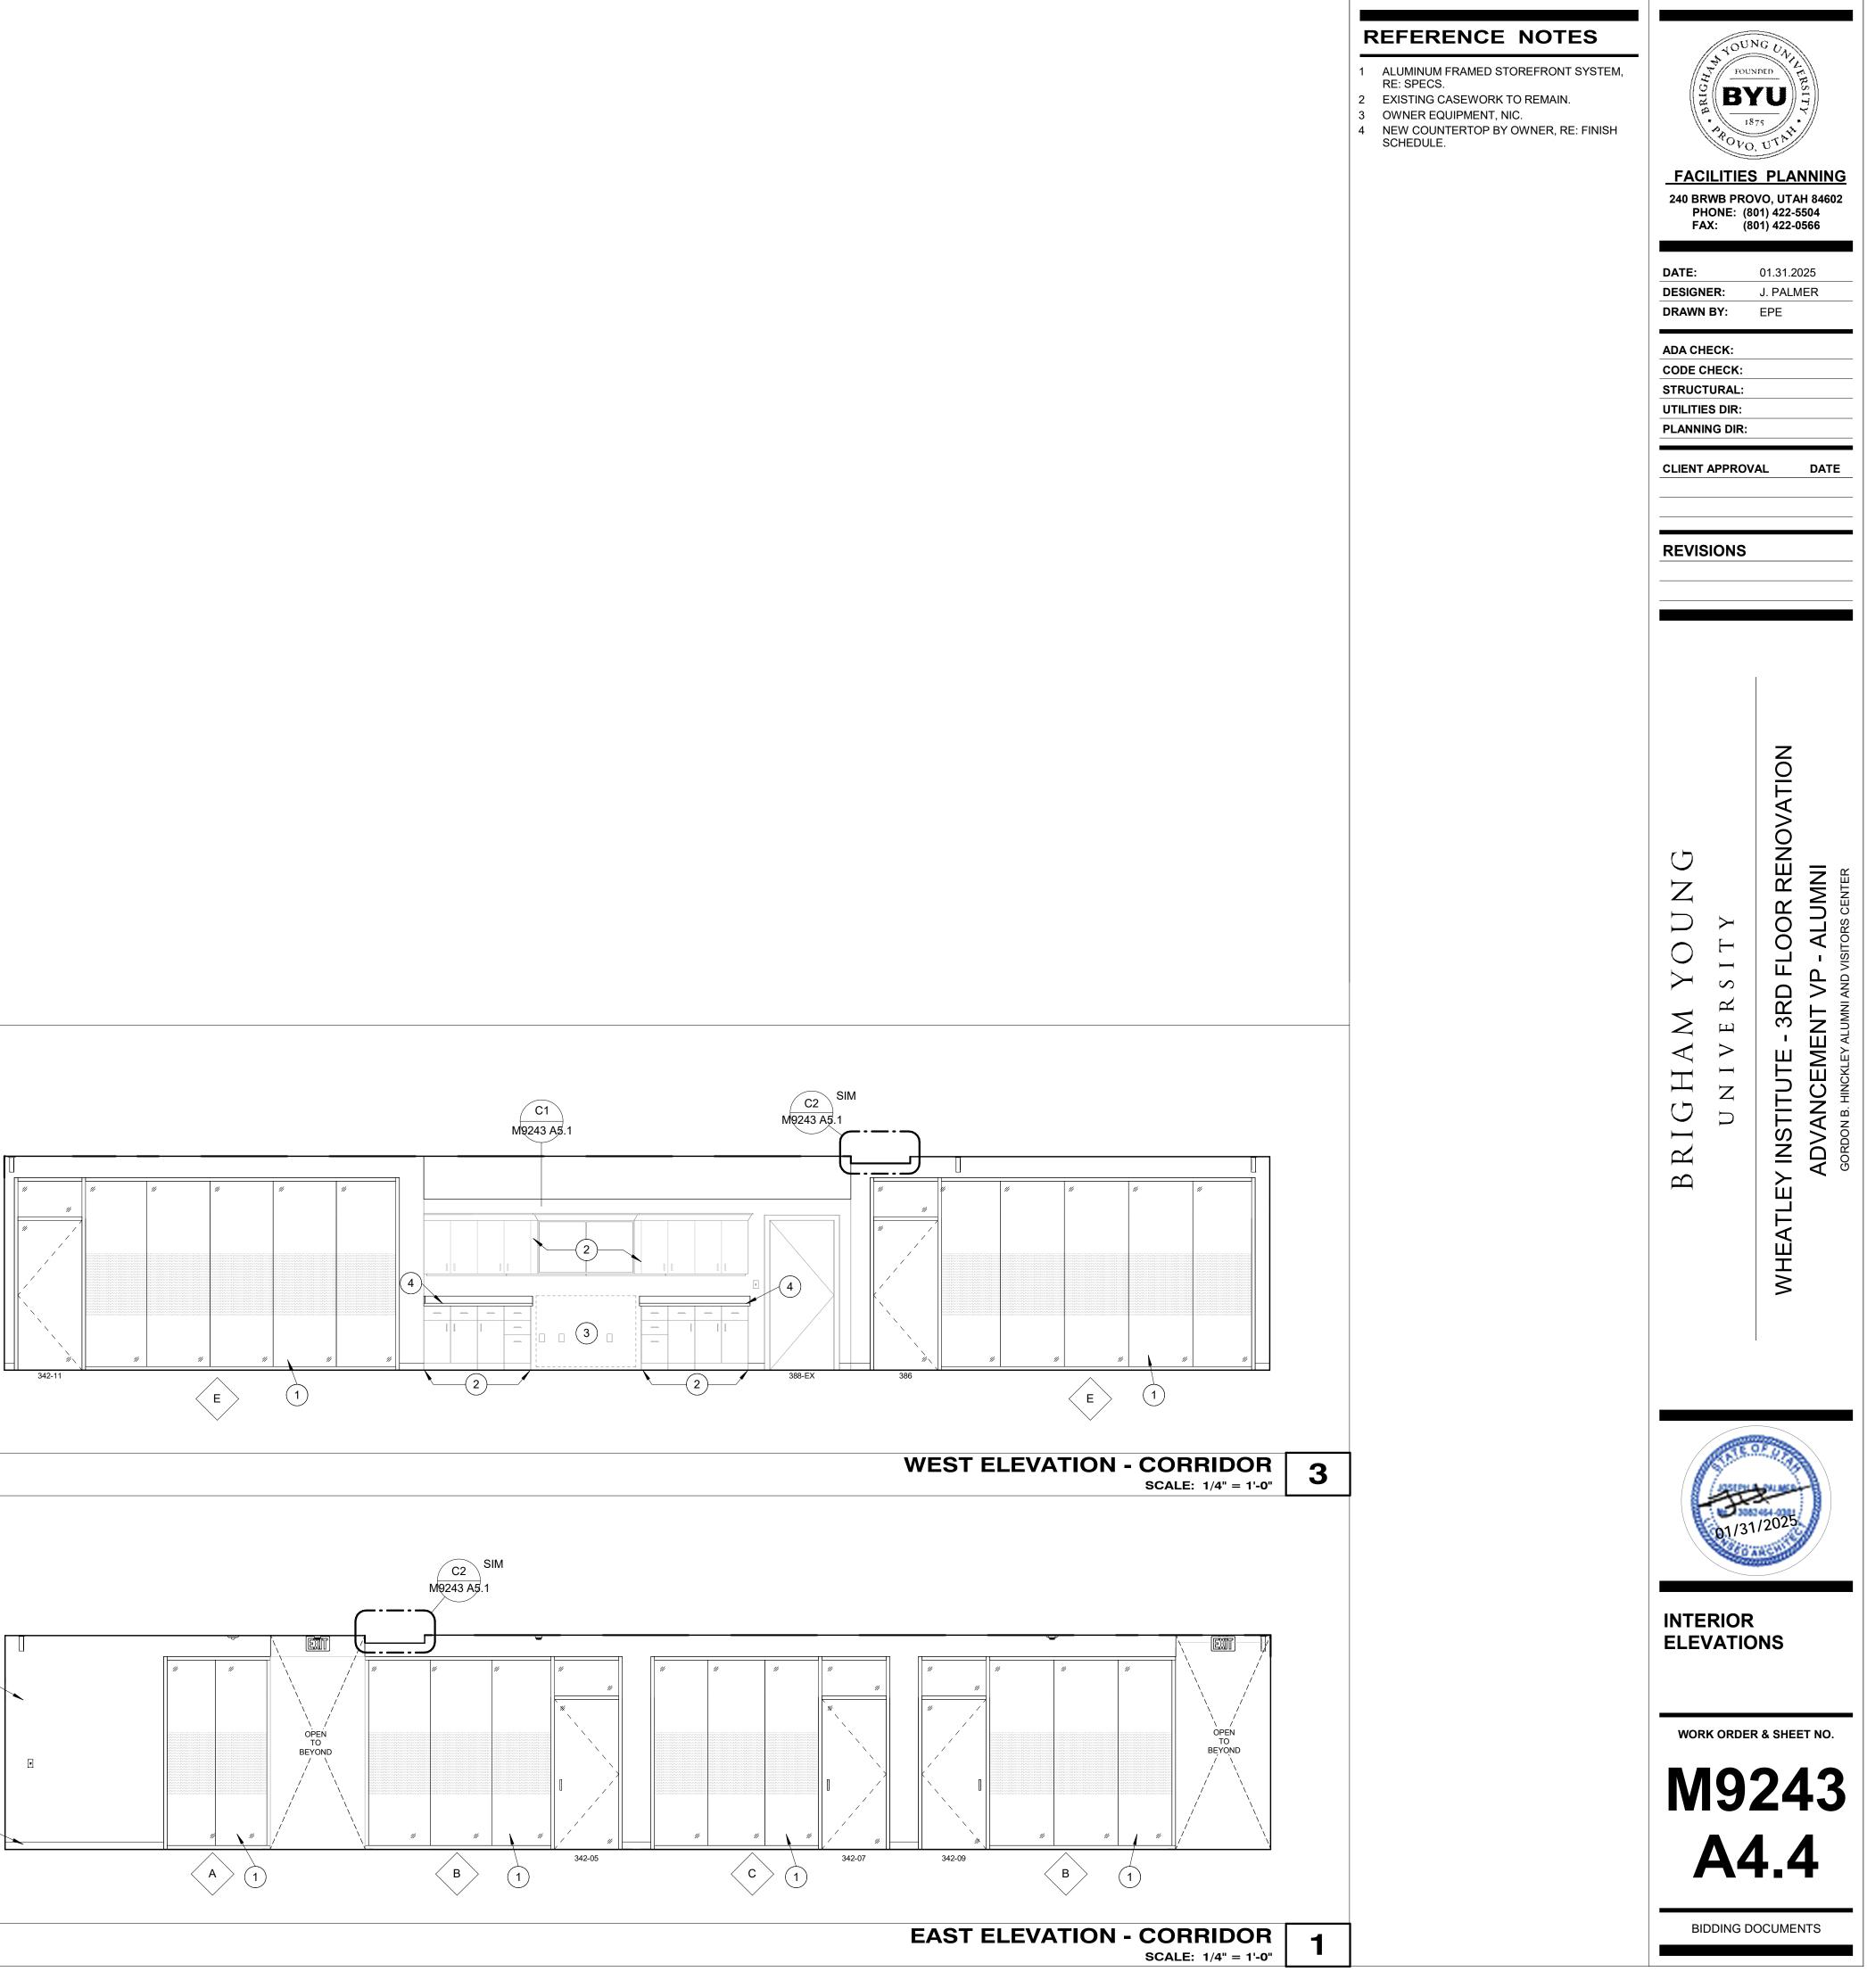

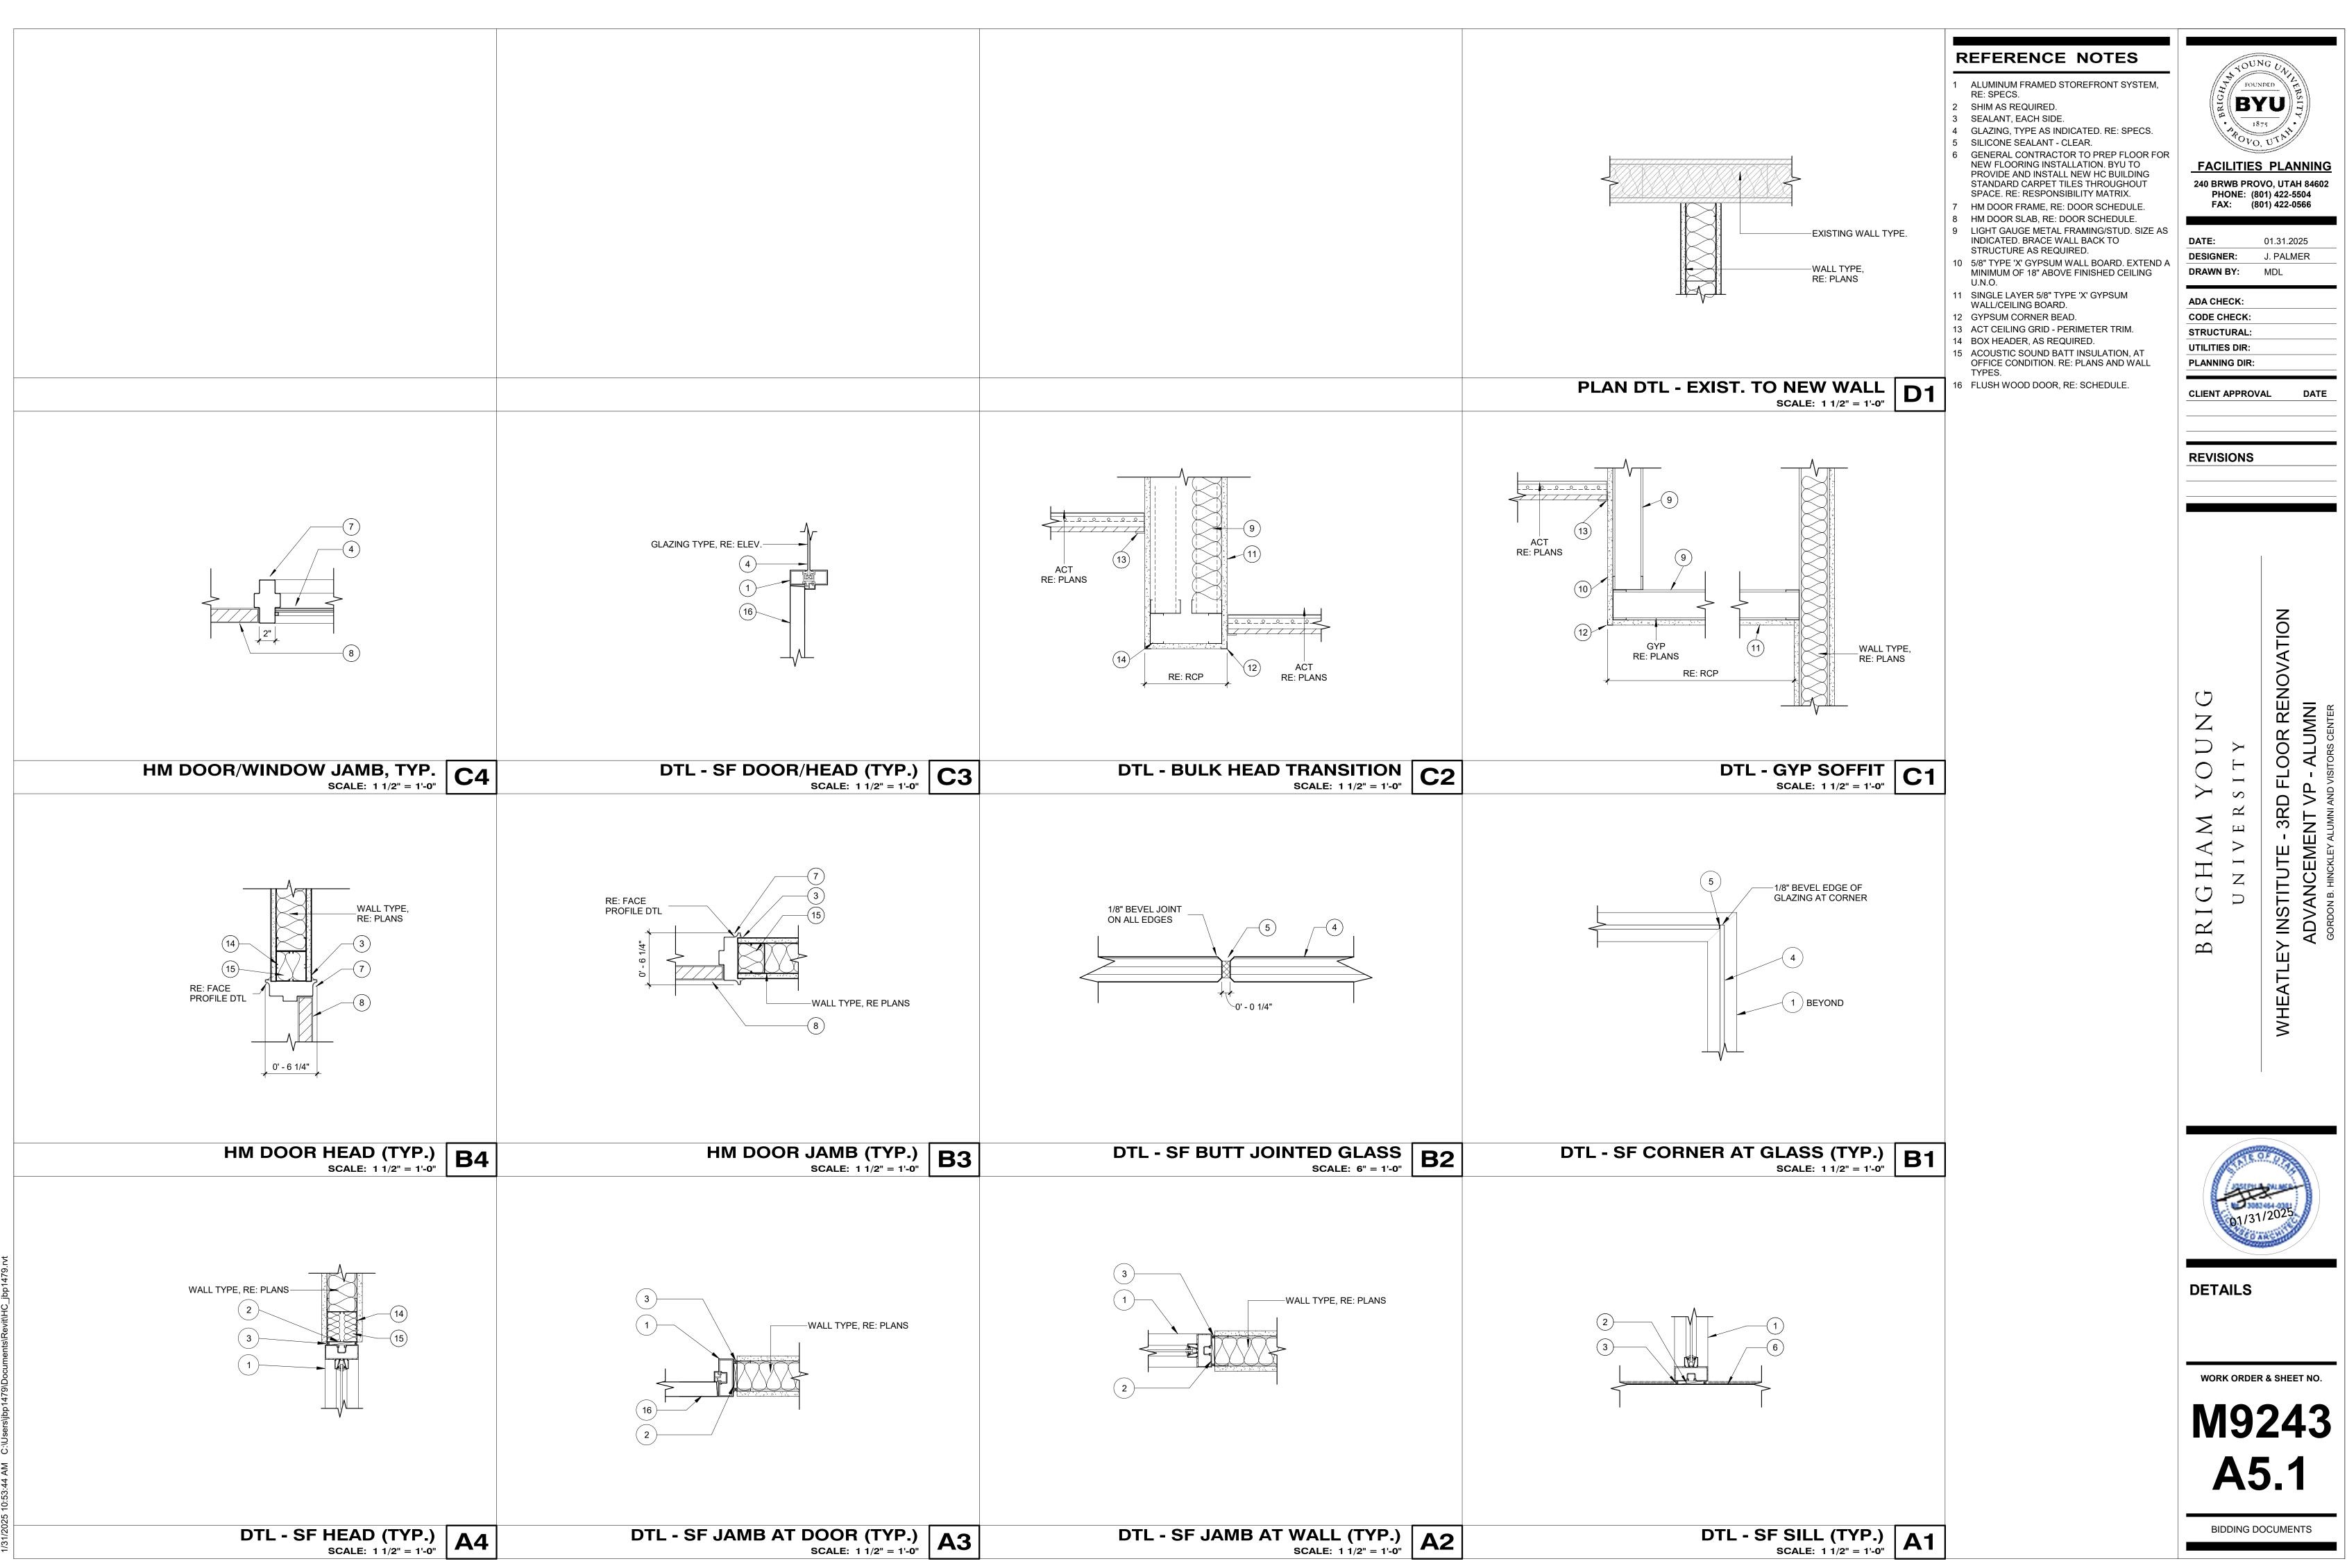

	M9243 DOOR SCHEDULE											
			DOOR			FRA	ME					
MARK	w	SIZE HT	т	MATL	EL	MATL	EL	HEAD DTL	JAMB DTL	HDWR FUNCTION	SET #	Comments
329B-EX	3' - 0"	7' - 0"	1 3/4"	WD	FG	HM	4	-	-	EXIST.		EXISTING DOOR, NEW HARDWARE - PROTECT FROM DAMAGE
337-EX	3' - 0"	7' - 0"	1 3/4"	WD	F	HM	1	-	-	EXIST.		EXISTING DOOR, NIC - PROTECT FROM DAMAGE
340-EX	3' - 6"	7' - 0"	1 3/4"	WD	FG	HM	3	-	-	EXIST.		EXISTING DOOR, NIC - PROTECT FROM DAMAGE
342-01	3' - 0"	7' - 0"	1 3/4"	WD	F	AL	Α	C3/A1.9	A3/A1.9	OFFICE		
342-02	3' - 0"	7' - 0"	1 3/4"	WD	F	AL	Α	C3/A1.9	A3/A1.9	OFFICE		
342-03	3' - 0"	7' - 0"	1 3/4"	WD	F	AL	А	C3/A1.9	A3/A1.9	OFFICE		
342-04	3' - 0"	7' - 0"	1 3/4"	WD	F	AL	А	C3/A1.9	A3/A1.9	OFFICE		
342-05	3' - 0"	7' - 0"	1 3/4"	WD	F	AL	В	C3/A1.9	A3/A1.9	OFFICE		
342-06	3' - 0"	7' - 0"	1 3/4"	WD	F	AL	В	C3/A1.9	A3/A1.9	OFFICE		
342-07	3' - 0"	7' - 0"	1 3/4"	WD	F	AL	С	C3/A1.9	A3/A1.9	OFFICE		
342-08	3' - 0"	7' - 0"	1 3/4"	WD	F	AL	С	C3/A1.9	A3/A1.9	OFFICE		
342-09	3' - 0"	7' - 0"	1 3/4"	WD	F	AL	В	C3/A1.9	A3/A1.9	OFFICE		
342-10	3' - 0"	7' - 0"	1 3/4"	WD	F	AL	В	C3/A1.9	A3/A1.9	OFFICE		
342-11	3' - 0"	7' - 0"	1 3/4"	WD	FG	AL	Е	C3/A1.9	A3/A1.9	OFFICE		
344-EX	3' - 0"	7' - 0"	1 3/4"	WD	F	HM	1	-	-	EXIST.		EXISTING DOOR, NIC - PROTECT FROM DAMAGE
384A	3' - 0"	7' - 0"	1 3/4"	WD	FG	HM	4	B4/A5.1	B3/A5.1	PASSAGE		REUSE EXISTING DOOR FRAME, NEW DOOR SLAB & HARDWARE - PROTECT FROM DAMAGE
384B	3' - 0"	7' - 0"	1 3/4"	WD	FG	HM	4	B4/A5.1	B3/A5.1	PASSAGE		
386	3' - 0"	7' - 0"	1 3/4"	WD	FG	AL	Е	C3/A1.9	A3/A1.9	OFFICE		
388-EX	3' - 0"	7' - 0"	1 3/4"	WD	F	HM	1	-	-	EXIST.		EXISTING DOOR, NIC - PROTECT FROM DAMAGE
390	3' - 0"	7' - 0"	1 3/4"	WD	F	AL	D	C3/A1.9	A3/A1.9	OFFICE		
392	3' - 0"	7' - 0"	1 3/4"	WD	F	AL	D	C3/A1.9	A3/A1.9	OFFICE		


#### **DOOR MATERIALS & TYPES**


ALUMINUM FRAMED STOREFRONT GLASS (TEMPERED) AL

GL HM


HOLLOW METAL WOOD - MATCH BUILDING STANDARD WD


FLUSH NARROW LITE (TEMPERED GLASS) FULL GLAZED N FG

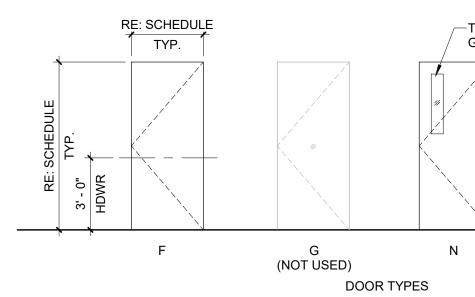

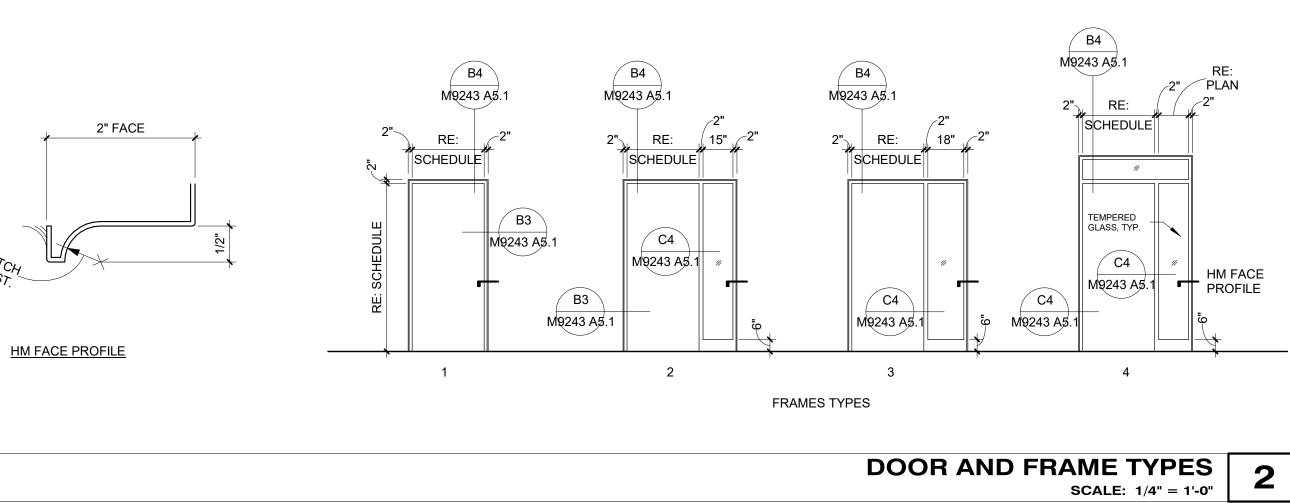


					ROO	M FI	NISH	SCHE	DUL	E
ROOM					WA	LLS			HEIGHT	
NO.	ROOM NAME	FLOOR	BASE	NORTH	EAST	SOUTH	WEST	CEILING	(A.F.F.)	COM
337	STO.	CPT	CB	PT-1	PT-1	PT-1	PT-1	EX - GYP		VAULTED CEILING
342	OPEN OFFICE	CPT	СВ	PT-1	PT-1	PT-1	PT-1	ACT	VARIES	RE: RCP FOR GYP SOFFIT PORTIO CEILINGS.
342-1	OFFICE	CPT	CB	PT-1	PT-2	PT-1	PT-1	ACT	10'-6"	
342-2	OFFICE	CPT	CB	PT-1	PT-1	PT-1	PT-2	ACT	10'-6"	
342-3	OFFICE	CPT	CB	PT-1	PT-2	PT-1	PT-1	ACT	10'-6"	
342-4	OFFICE	CPT	CB	PT-1	PT-1	PT-1	PT-2	ACT	10'-6"	
342-5	OFFICE	CPT	CB	PT-1	PT-2	PT-1	PT-1	ACT	10'-6"	
342-6	OFFICE	CPT	CB	PT-1	PT-1	PT-1	PT-2	ACT	10'-6"	
342-7	OFFICE	CPT	CB	PT-1	PT-2	PT-1	PT-1	ACT	10'-6"	
342-8	OFFICE	CPT	CB	PT-1	PT-1	PT-1	PT-2	ACT	10'-6"	
342-9	OFFICE	CPT	CB	PT-1	PT-2	PT-1	PT-1	ACT	10'-6"	
342-10	OFFICE	CPT	CB	PT-1	PT-1	PT-1	PT-2	ACT	10'-6"	
342-11	INITIATIVE #1	CPT	CB	PT-1	PT-1	PT-2	PT-1	EX - GYP		VAULTED CEILING
384	CORRIDOR	CPT	CB	PT-1	PT-1	PT-1	PT-1			
386	INITIATIVE #2	CPT	CB	PT-1	PT-1	PT-2	PT-1	EX - GYP		VAULTED CEILING
388	STO.	CPT	CB	PT-1	PT-1	PT-1	PT-1	EX - GYP		VAULTED CEILING
390	OFFICE	CPT	CB	PT-1	PT-1	PT-2	PT-1	ACT	10'-0"	
392	OFFICE	CPT	CB	PT-1	PT-1	PT-2	PT-1	ACT	10'-0"	

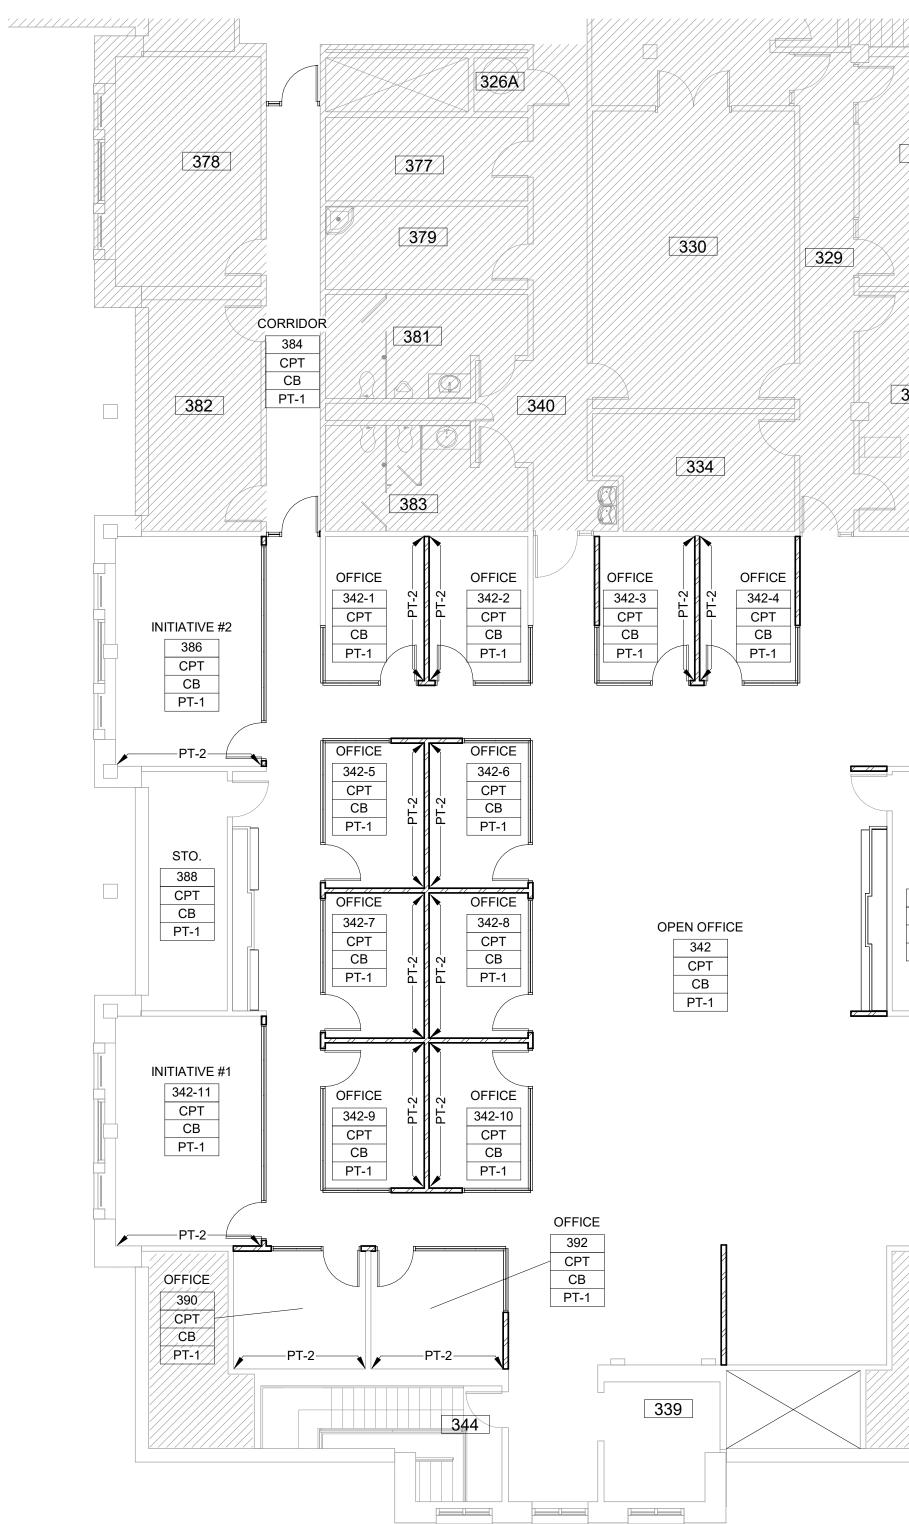


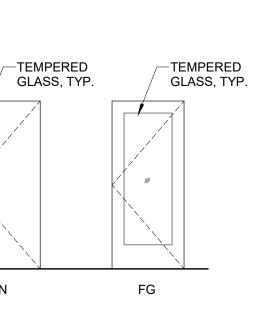

FINISH FI

OMMENTS	MATERIAL FINISH LI		HOUN FOUN BY BY	- VE
RTIONS AND TIE-IN TO EXISTING	AL: ALUMINUM - BLACK AND CEILING TILE & GRID ACT: ACOUSTIC CEILING TILE MANUF.: PRODUCT: SIZE: EDGE: COLOR: GRID: REVEAL:	DIZED FINISH	FACILITIES 240 BRWB PRO PHONE: (8	
	MANUF.: PRODUCT: PATTERN: STOCK NO.: SIZE: FLOORING (NIC) CPT-1: CARPET TILE , BUILDING MANUF.: PRODUCT: COLOR: SIZE: GLAZING G-1 LAMIATED GLASS - ALL INTE MANUF.: THICKNESS: STC:	ONS, RE: WINDOW ELEVATIONS) 3M FASARA GLASS FINISHES GEOMETRIC GRID (SH2FGGD) 7100126668 50" WIDE (INSTALL HORIZONTAL) S STANDARD MANNINGTON ALIGN RADIAN 2' x 2'	DATE: DESIGNER: DRAWN BY: ADA CHECK: CODE CHECK: STRUCTURAL: UTILITIES DIR: PLANNING DIR: CLIENT APPROV	01.31.2025 J. PALMER MDL
331 331 STO. 37 CPT CB PT-1	SOLID SURFACE (NIC) SS-1: SOLID SURFACE COUNT WALL BASE (NIC) CB-1: CARPET WALL BASE MANUF.: PRODUCT: COLOR: HEIGHT: WOOD VENEER WV-1: WOOD VENEER FINISH ( SPECIES:	TERTOP MANNINGTON ALIGN RADIAN 4" COORS AND CASEWORK) CHEERY (MATCH EXISTING)	BRIGHAM YOUNG UNIVERSITY	WHEATLEY INSTITUTE - 3RD FLOOR RENOVATION ADVANCEMENT VP - ALUMNI GORDON B. HINCKLEY ALUMNI AND VISITORS CENTER
			DOOR AND SCHEDUL WORK ORDER M92 A6	E R & SHEET NO. <b>243</b>
<b>LOOR PLAN</b> SCALE: 1/8" = 1'-0"				JUUMENIS

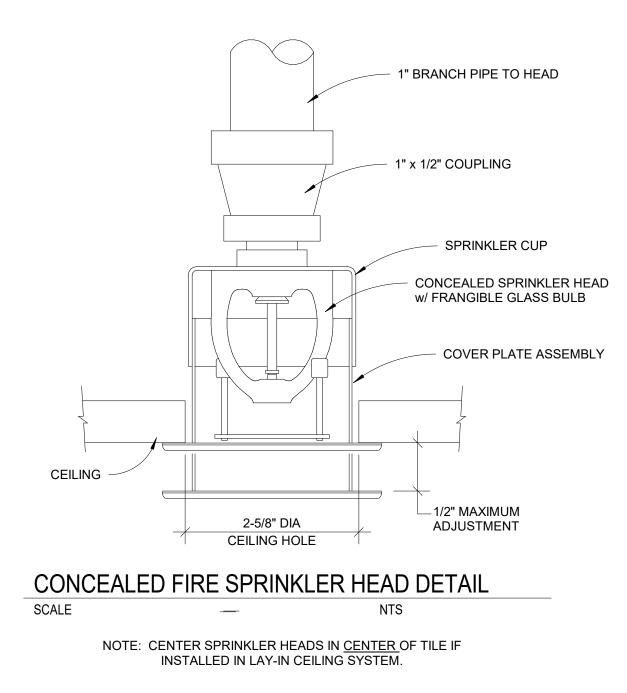

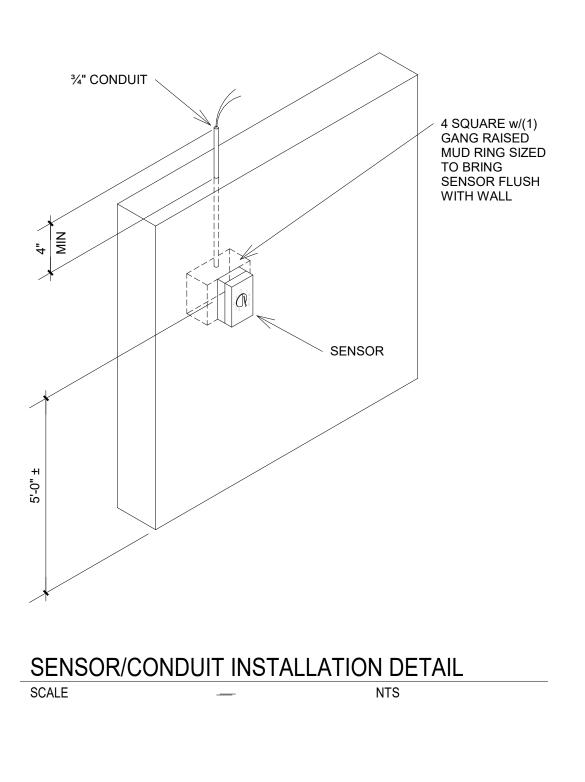

EXISTING DUAL DUCT VAV BOX RELOCATION SCHEDULE								
ID	STATUS	SIZE, COOLING (IN)	SIZE, HEATING (IN)	NOTES				
EV1	EXISTING	8	6	1				
EV2	EXISTING	12	8	1				
EV3	EXISTING	10	8	1				
EV4	EXISTING	14	10	1				
EV5	EXISTING	10	8	1				
EV6	EXISTING	10	8	1				
EV7	EXISTING	8	6	1				
EV8	EXISTING	10	8	1				


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1. PROVIDE BID ALTERNATE PRICE TO MODIFY AND EXTEND THE EXISTING DUCTWORK ASSOCIATED WITH THIS EXISTING DUAL DUCT VAV BOX AND RELOCATE THIS EXISTING DUAL DUCT VAV BOX DOWN TO WITHIN 18 INCHES OF THE CEILING. REFER TO MECHANICAL PLAN FOR EXISTING LOCATIONS AND DUCT SIZES. FIELD VERIFY EXISTING CONDITIONS.

#### NOT-IN-CONTRA

ITEM

MECHANICAL CONTROLS HARDWARE (BOTH SYSTEM AND TERMINAL UNITS) I MECHANICAL CONTROLS RACEWAY MECHANICAL CONTROLS PROGRAMMING (SOFTWARE - BOTH SYSTEM AND 1



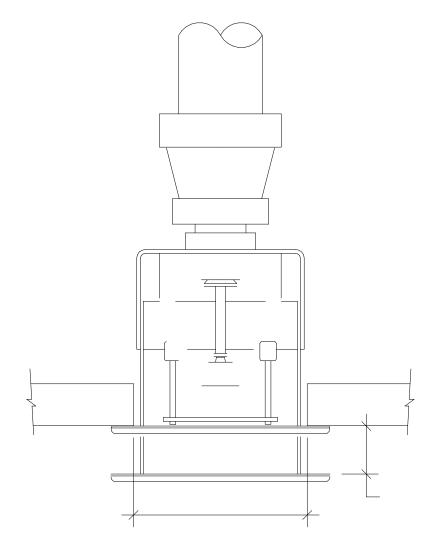

	AIR HANDLING SYMBOLS
SYMBOL	DESCRIPTION
_\-►	AIR FLOW DIRECTION
$\backslash / \backslash \backslash \rangle$	OPPOSED BLADE DAMPER
/////	PARALLEL BLADE DAMPER
	SUPPLY DUCT (CROSS SECTION)
	RETURN AIR or EXHAUST (CROSS SECTION)
24x12	DUCT SIZE, INSIDE CLEAR DIMENSION
24x12+1"AL	DUCT w/ACOUSTIC LINING, INSIDE CLEAR DIMENSION
RISE	DUCT RISE
	DROP or RISE IN SUPPLY DUCT
	SLOT SUPPLY DIFFUSER or REGISTER
\	CEILING SUPPLY DIFFUSER or REGISTER
	CEILING RETURN/EXHAUST AIR REGISTER or GRILLE
	SIDEWALL SUPPLY DIFFUSER or REGISTER
	SIDEWALL RETURN/EXHAUST AIR REGISTER or GRILLE
	AIR TURNING VANES
	FLEXIBLE CONNECTION
	FLEXIBLE DUCT
F.D.	FIRE DAMPER
	HAND DAMPER
	45° SQUARE to SQUARE TAKE-OFF
	45° SQUARE to ROUND TAKE-OFF
	MITCO TYPE VARIABLE AIR VALVE
	VARIABLE VOLUME AIR VALVE
T	PNEUMATIC THERMOSTAT
S	STAEFA SENSOR
DG	DOOR GRILLE
	UNDER CUT DOOR

	GRILLES, REGISTERS, AND DIFFUSERS SCHEDULE								
ID	MFR	MODEL	D	ESCRIPTION					
CD1	EH PRICE	SPD	FACE STYLE: SQUARE PLAQUE DIFFUSER FACE SIZE: 24" x 24", 24" x 12" OR 12" x 12" AS REQUIRED TO FIT CEILING SPACE AVAILABLE MATERIAL: STEEL FINISH: B12 WHITE POWDERCOAT	MOUNTING-FRAME: SURFACE OR LAY-IN, (C/W CEILING TYPE.) PATTERN: 360° RADIAL HORIZONTAL AIR PATTERN DAMPER: OPPOSED BLADE MAX NC - 30 DAMPER: NONE REMOVABLE FACE					
RG1	EH PRICE	PFRF	FACE STYLE: PERFORATED FACE SIZE: 24" x 24", 24" x 12" OR 12" x 12" AS REQUIRED TO FIT CEILING SPACE AVAILABLE APPLICATION: AIR RETURN MATERIAL:FRAME; ALUMINUM FINISH: FACE; B12 WHITE POWDERCOAT	MOUNTING-FRAME: SURFACE OR LAY-IN, (C/W CEILING TYPE.) DAMPER: NONE MAX NC - 30					
			GRILLE, USE HERCULES INDUSTRIES MODEL SB22	UCTBOARD CAN WITH BAFFLE 22"x22" or 10"x22" TO MATC 222 OR SB2210.					
RG2	EH PRICE	530	FACE STYLE: SIDE WALL RETURN AIR GRILLE ARRANGEMENT: STATIONARY HORIZONTAL BLADE ORIENTATION: 45 DEG DEFLECTION VANES SPACED AT 3/4 INCH CENTERS. FRONT BLADES PARALLEL TO SHORT DIMENSION. MATERIAL: STEEL FINISH: B12 WHITE POWDERCOAT	FRAME: 1.25 INCH FLAT / BORDER MOUNTING: SURFACE PATTERN: PERMANENT 45 DEGREE DEFLECTION DAMPER: OPPOSED BLADE MAX NC - 30					
NOTES: AL	NOTES: ALL DIFFUSERS SHALL BE CD1 AND ALL CEILING RETURNS SHALL BE RG1.								

		DUAL DL	JCT VAV B	OX S	CHEDULE		
ID	MFR	MODEL	ROOMS SERVED	SIZE	CFM	HOT/COLD	NOTES
V1	EH PRICE	SDV	1&2	6	110	COLD	
V2	EH PRICE	SDV	1&2	6	60	HOT	
V3	EH PRICE	SDV	3 & 14	6	110	COLD	
V4	EH PRICE	SDV	3 & 14	6	60	HOT	
V5	EH PRICE	SDV	4 & 5	6	110	COLD	
V6	EH PRICE	SDV	4 & 5	6	60	HOT	
V7	EH PRICE	SDV	6&7	6	110	COLD	
V8	EH PRICE	SDV	6&7	6	60	HOT	
V9	EH PRICE	SDV	8 & 9	6	110	COLD	
V10	EH PRICE	SDV	8 & 9	6	60	НОТ	
V11	EH PRICE	SDV	10 & 11	6	110	COLD	
V12	EH PRICE	SDV	10 & 11	6	60	HOT	

BID ALTERNATE #2


RACT (NIC) COORDINATION LIST											
	FURNISHED BY BYU	INSTALLED BY BYU OR BYU VENDOR	INSTALLED BY CONTRACTOR	FURNISHED BY CONTRACTOR							
) BY ATKINSON	Х		Х								
			Х	Х							
TERMINAL UNITS) BY ATKINSON	Х	Х									


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	PIPING LEGEND
SYMBOL	DESCRIPTION DOMESTIC COLD WATER
	DOMESTIC HOT WATER
	DOMESTIC HOT WATER RECIRCULATION
—— W ——	SOIL or WASTE
—— V ——	VENT
—— G ——	GAS
— HWS —	HOT WATER SUPPLY
— HWR —	HOT WATER RETURN
—ChWS —	CHILLED WATER SUPPLY
— ChWR —	CHILLED WATER RETURN
— CWS —	CONDENSING WATER SUPPLY
— CWR —	CONDENSING WATER RETURN
—— FP ——	FIRE PROTECTION
— D —	DRAIN
OX	
— NO — — A —	NITROUS OXIDE AIR
<u> </u>	BALL VALVE
	GATE VALVE
	GLOBE VALVE
	BUTTERFLY VALVE
	CHECK VALVE
	SOLENOID VALVE
	POST INDICATOR VALVE - (PIV)
	ANGLE VALVE
~~~~~~~~~~~~~~~~~~~~~~~~~~~~~~~~~~~~~~	SAFETY or RELIEF VALVE
	PLUG VALVE
HD>C	VALVE IN RISE
	PRESSURE REDUCING VALVE - (PRV)
	2 WAY CONTROL VALVE
	3 WAY CONTROL VALVE
	GAUGE with GAUGE COCK
 	GAUGE COCK
<u>,Ψ,</u>	THERMOMETER THERMOMETER or GAUGE WELL
<u>+</u>	AIR VENT with NEEDLE VALVE
	STRAINER with BLOWDOWN VALVE
	CONCENTRIC REDUCER
	ECCENTRIC REDUCER
	UNION
— X—	PIPE ANCHOR
	PIPE GUIDE
	GROOVED JOINT COUPLING
	NEW CONNECTION
	FLOW CONTROLLER
]	PIPE CAP
F.D.	BLIND FLANGE
F.S. R.D. F.C.O.	FLOOR DRAIN, FLOOR SINK, ROOF DRAIN
O <sup>F.U.U.</sup>	FLOOR CLEAN OUT
<u>w.c.</u> o.	WALL CLEAN OUT
C.O.T.G.	CLEAN OUT CLEAN OUT TO GRADE
	LOW PRESSURE STEAM
	LOW PRESSURE CONDENSATE
/	MEDIUM PRESSURE STEAM
// //	MEDIUM PRESSURE CONDENSATE
	HIGH PRESSURE STEAM
///	HIGH PRESSURE CONDENSATE
	IN LINE PUMP
	PRESSURE/TEMPERATURE TEST PLUG (P-T PLUG)
	ELBOW DROP IN PIPE
<u> </u>	TEE DROP IN PIPE
<u> </u>	RISE IN PIPE


240 BRV	LITIES VB PRO DNE: (80 :: (80 R: BY: CK: IECK: JRAL: G DIR: G DIR:	OTAT OTAT OTAT O, UTAH O1) 422-550 O1) 422-050 O1.3 J. JE J. JE	NING 84602 04
BRIGHAM YOUNG	UNIVERSITY	WHEATLEY INSTITUTE — 3RD FLOOR RENOVATION	ADVANCEMENT VP — ALUMNI GORDON B. HINCKLEY ALUMNI AND VISITORS CENTER
MECH LEGE SCHE DETA	ND, DUL		
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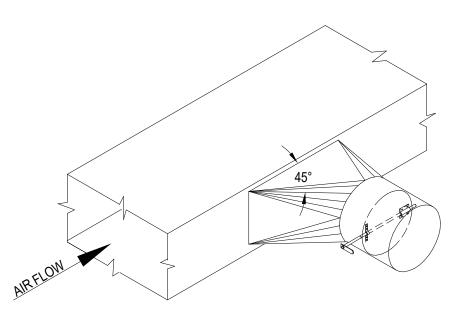




M9243 MECHANICAL PLAN SCALE: 1/8" = 1'-0"

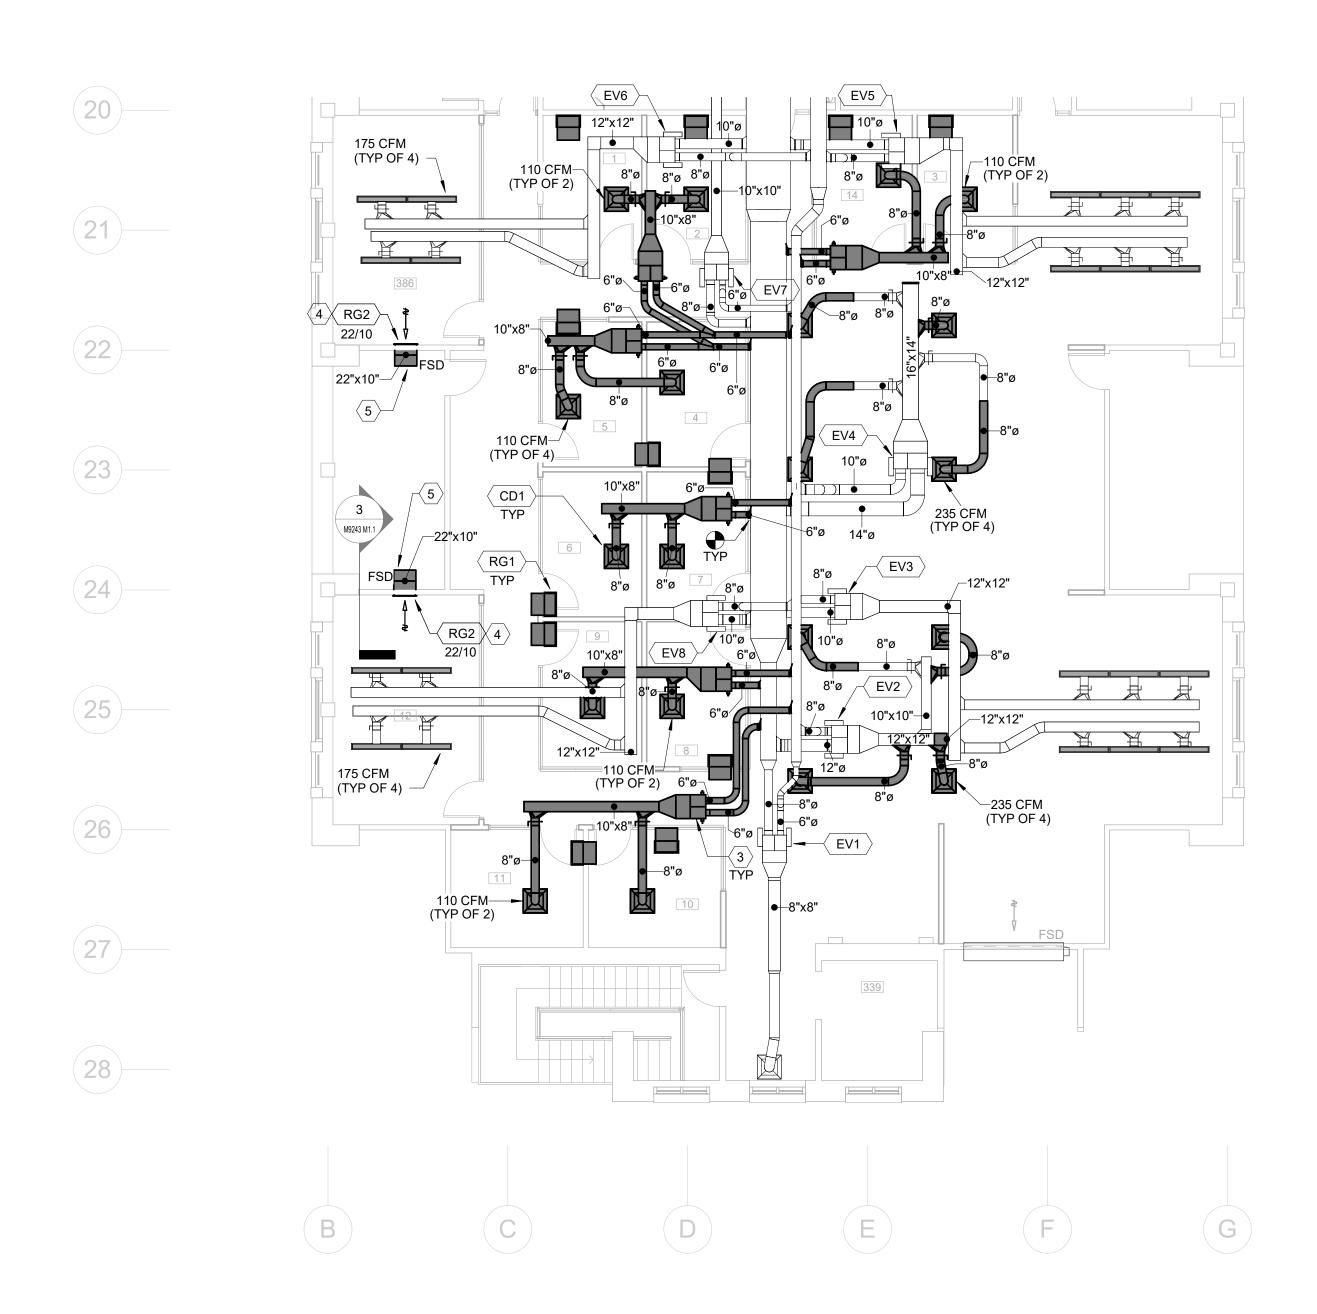

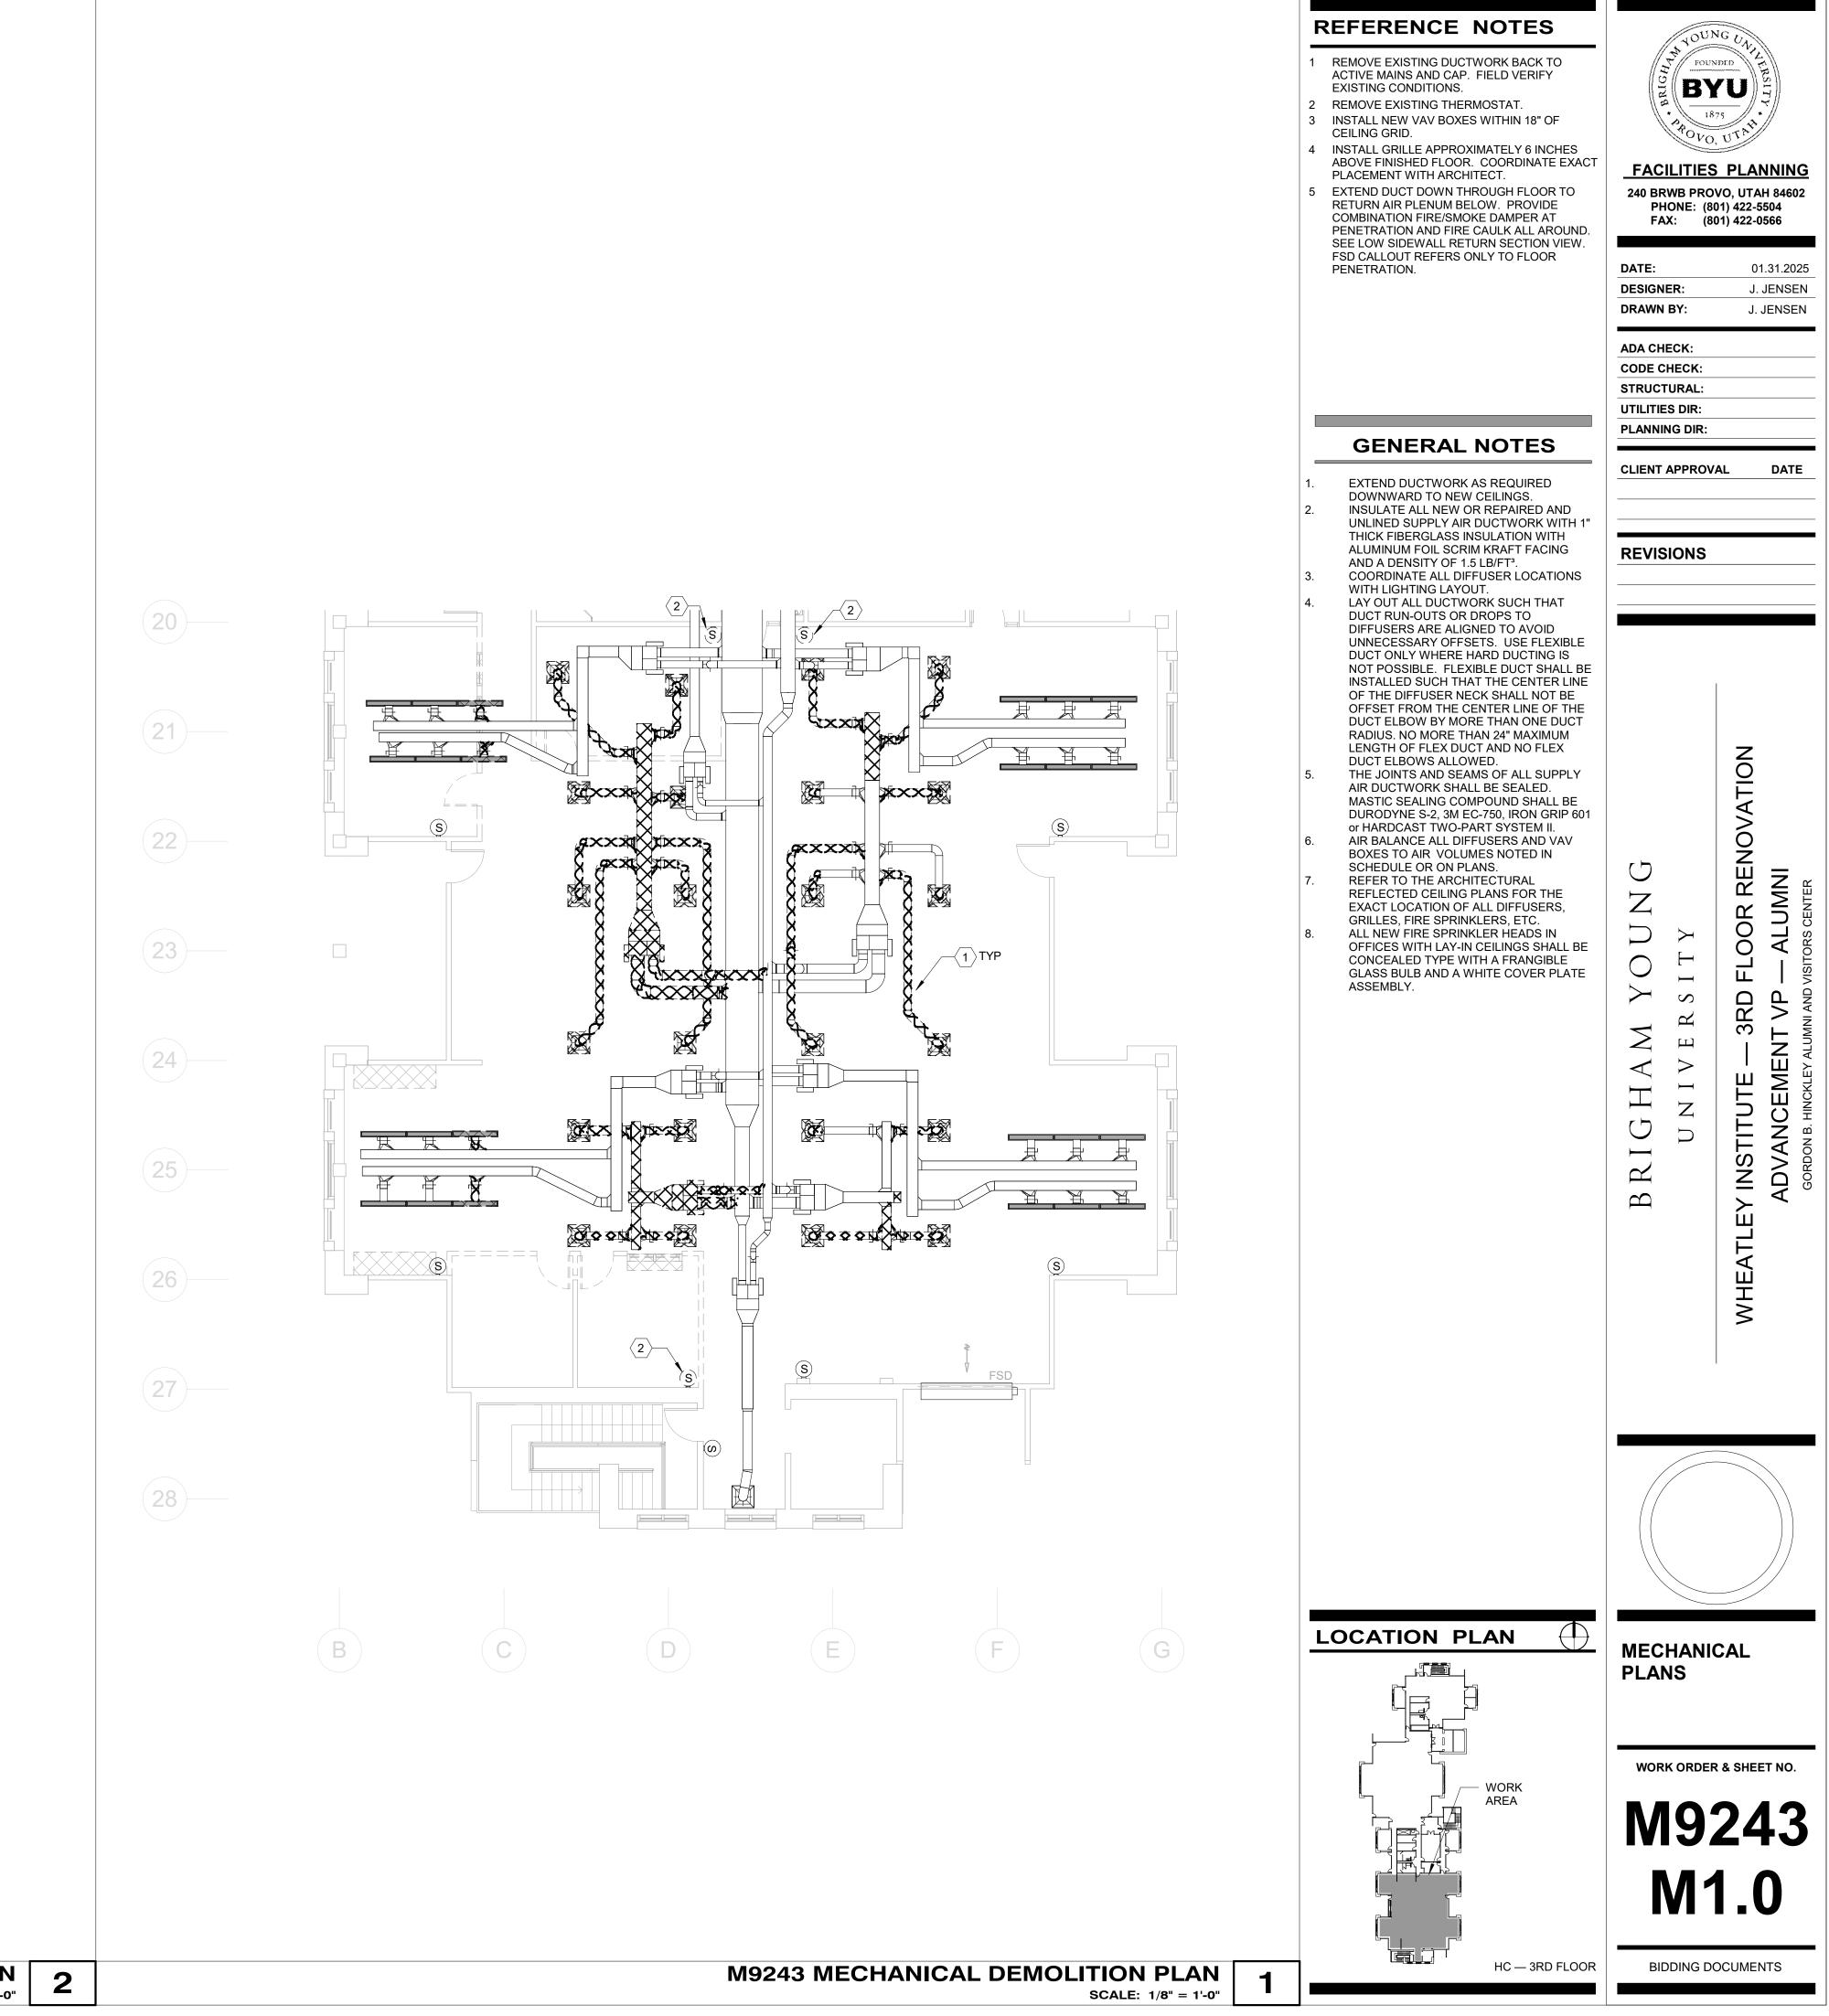

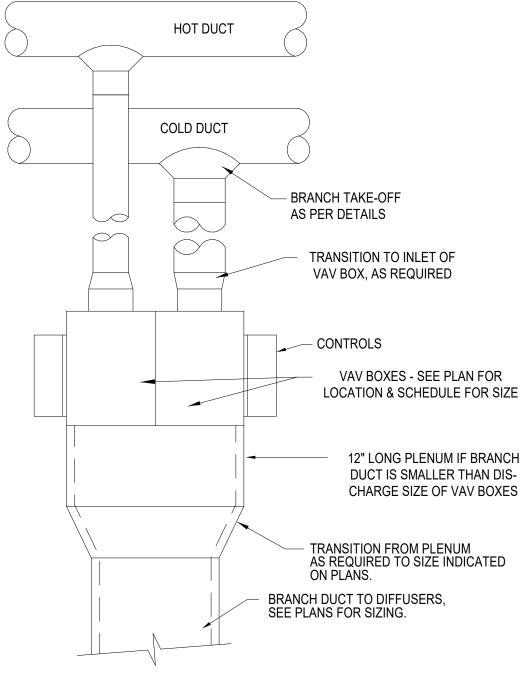


EQUAL.


HIGH EFFICIENCY TAKE-OFF w/DAMPER DETAIL SCALE \_\_\_\_\_


> NOTE: TAKE-OFFS SHOULD NOT BE INSTALLED CLOSER THAN TWO DUCT WIDTHS TO ELBOWS or INTERSECTIONS

VAV BOX INSTALLATION DETAIL SCALE NTS

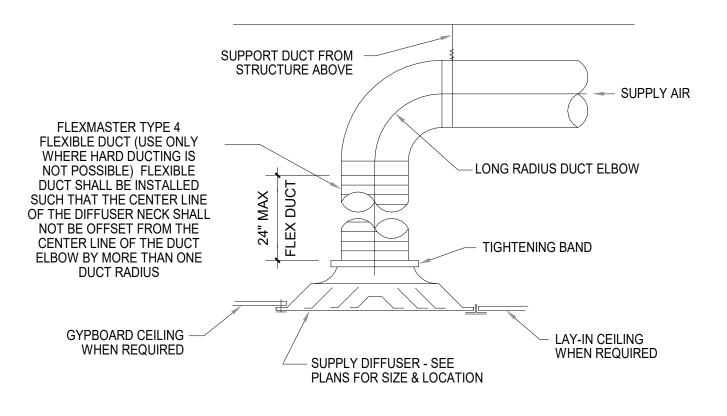



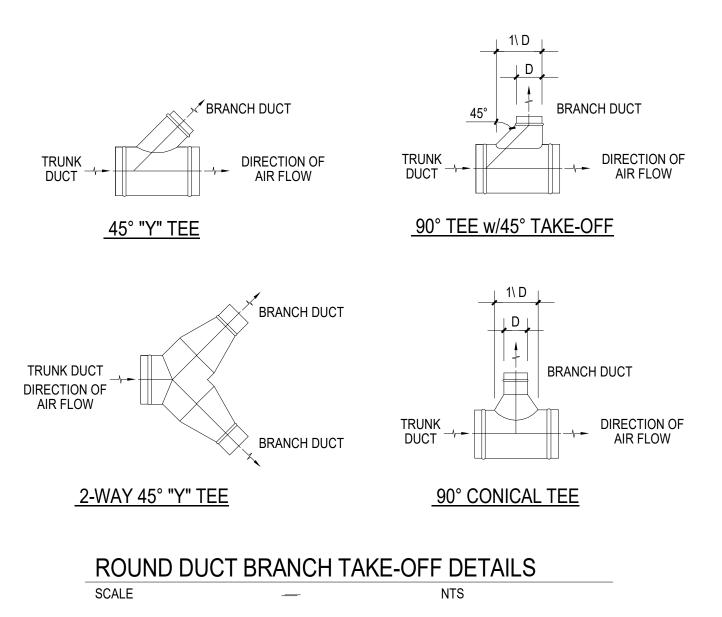

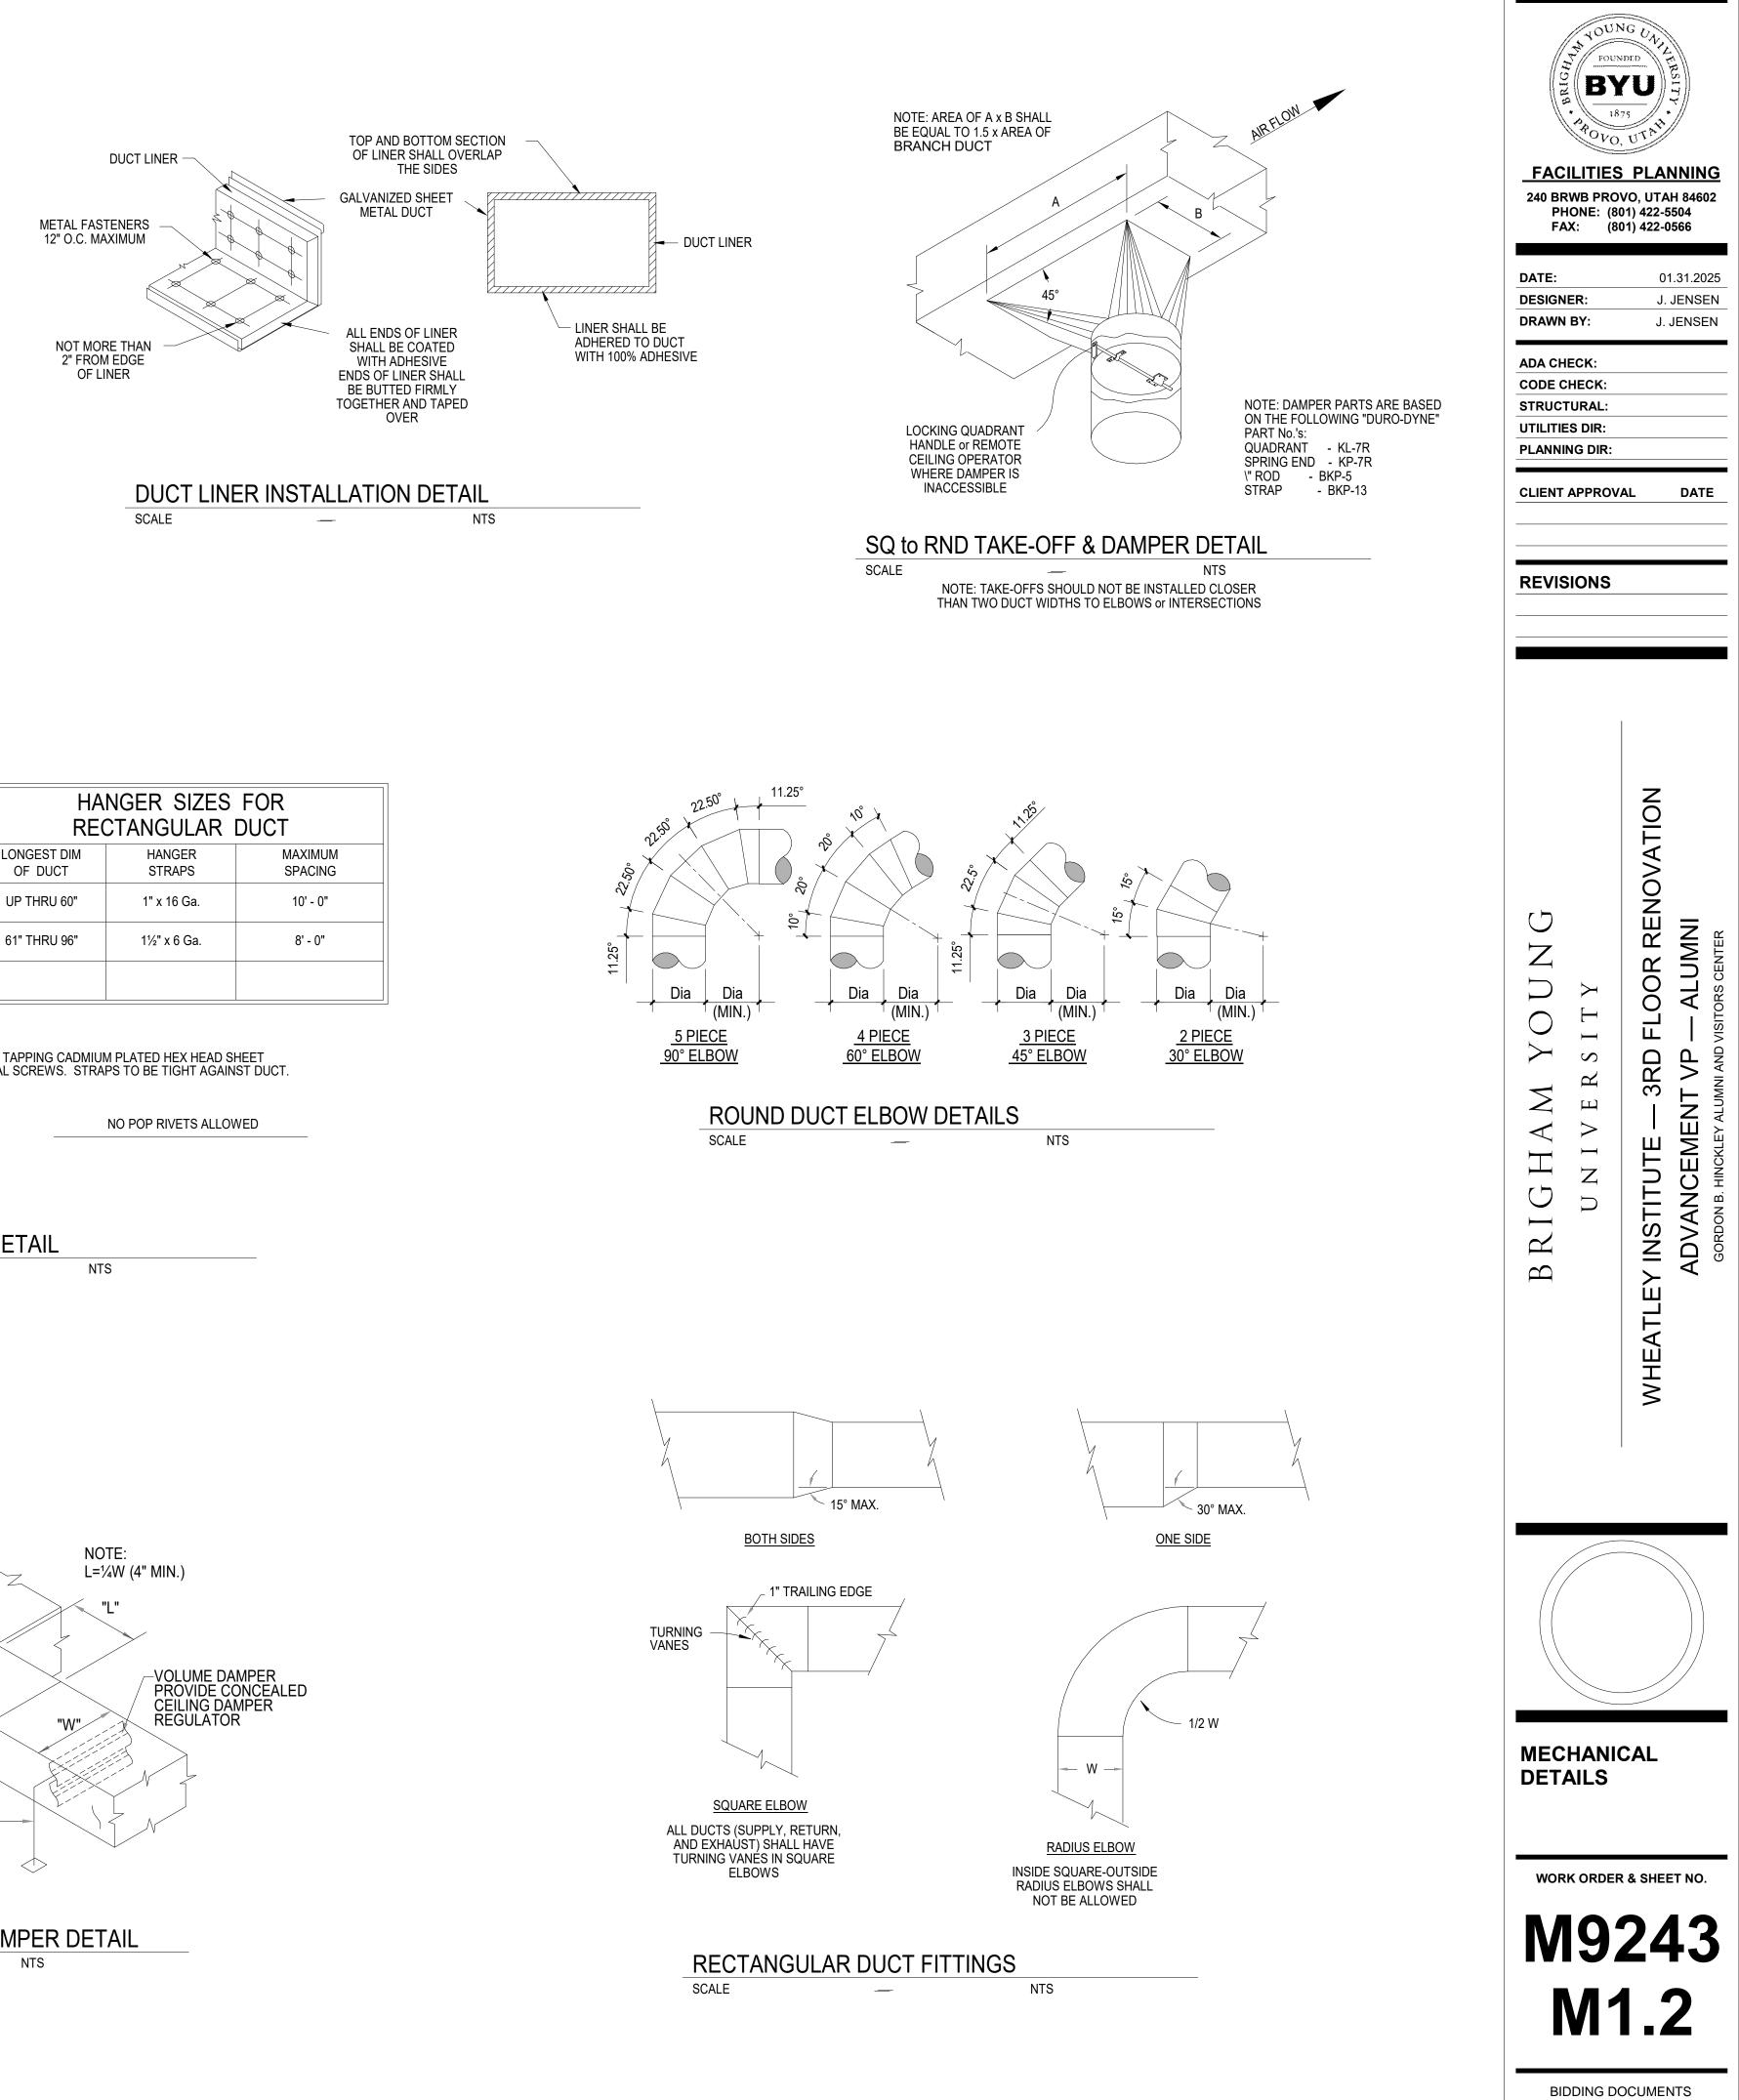


#### MANUFACTURED HIGH EFFICIENCY TAKE-OFF w/FLANGE AND 2" DAMPER HANDLE EXTENSION. HET SHALL HAVE AN ADJUSTABLE VOLUME DAMPER AND POSITIVE LOCKING HARDWARE. HET FLANGE SHALL BE SUPPLIED WITH AN ADHESIVE COATED DOUBLE FACED GASKET TO ASSURE A TIGHT SEAL. HET SHALL BE BUILT IN ACCORDANCE WITH SMACNA STANDARDS & SHALL BE TESTED BY ETL TESTING LABS. AS MANUFACTURED BY SHEET METAL CONNECTORS INC., OR


SCALE

\_\_\_\_

NTS

# LONGEST DIM OF DUCT HANGER STRAPS

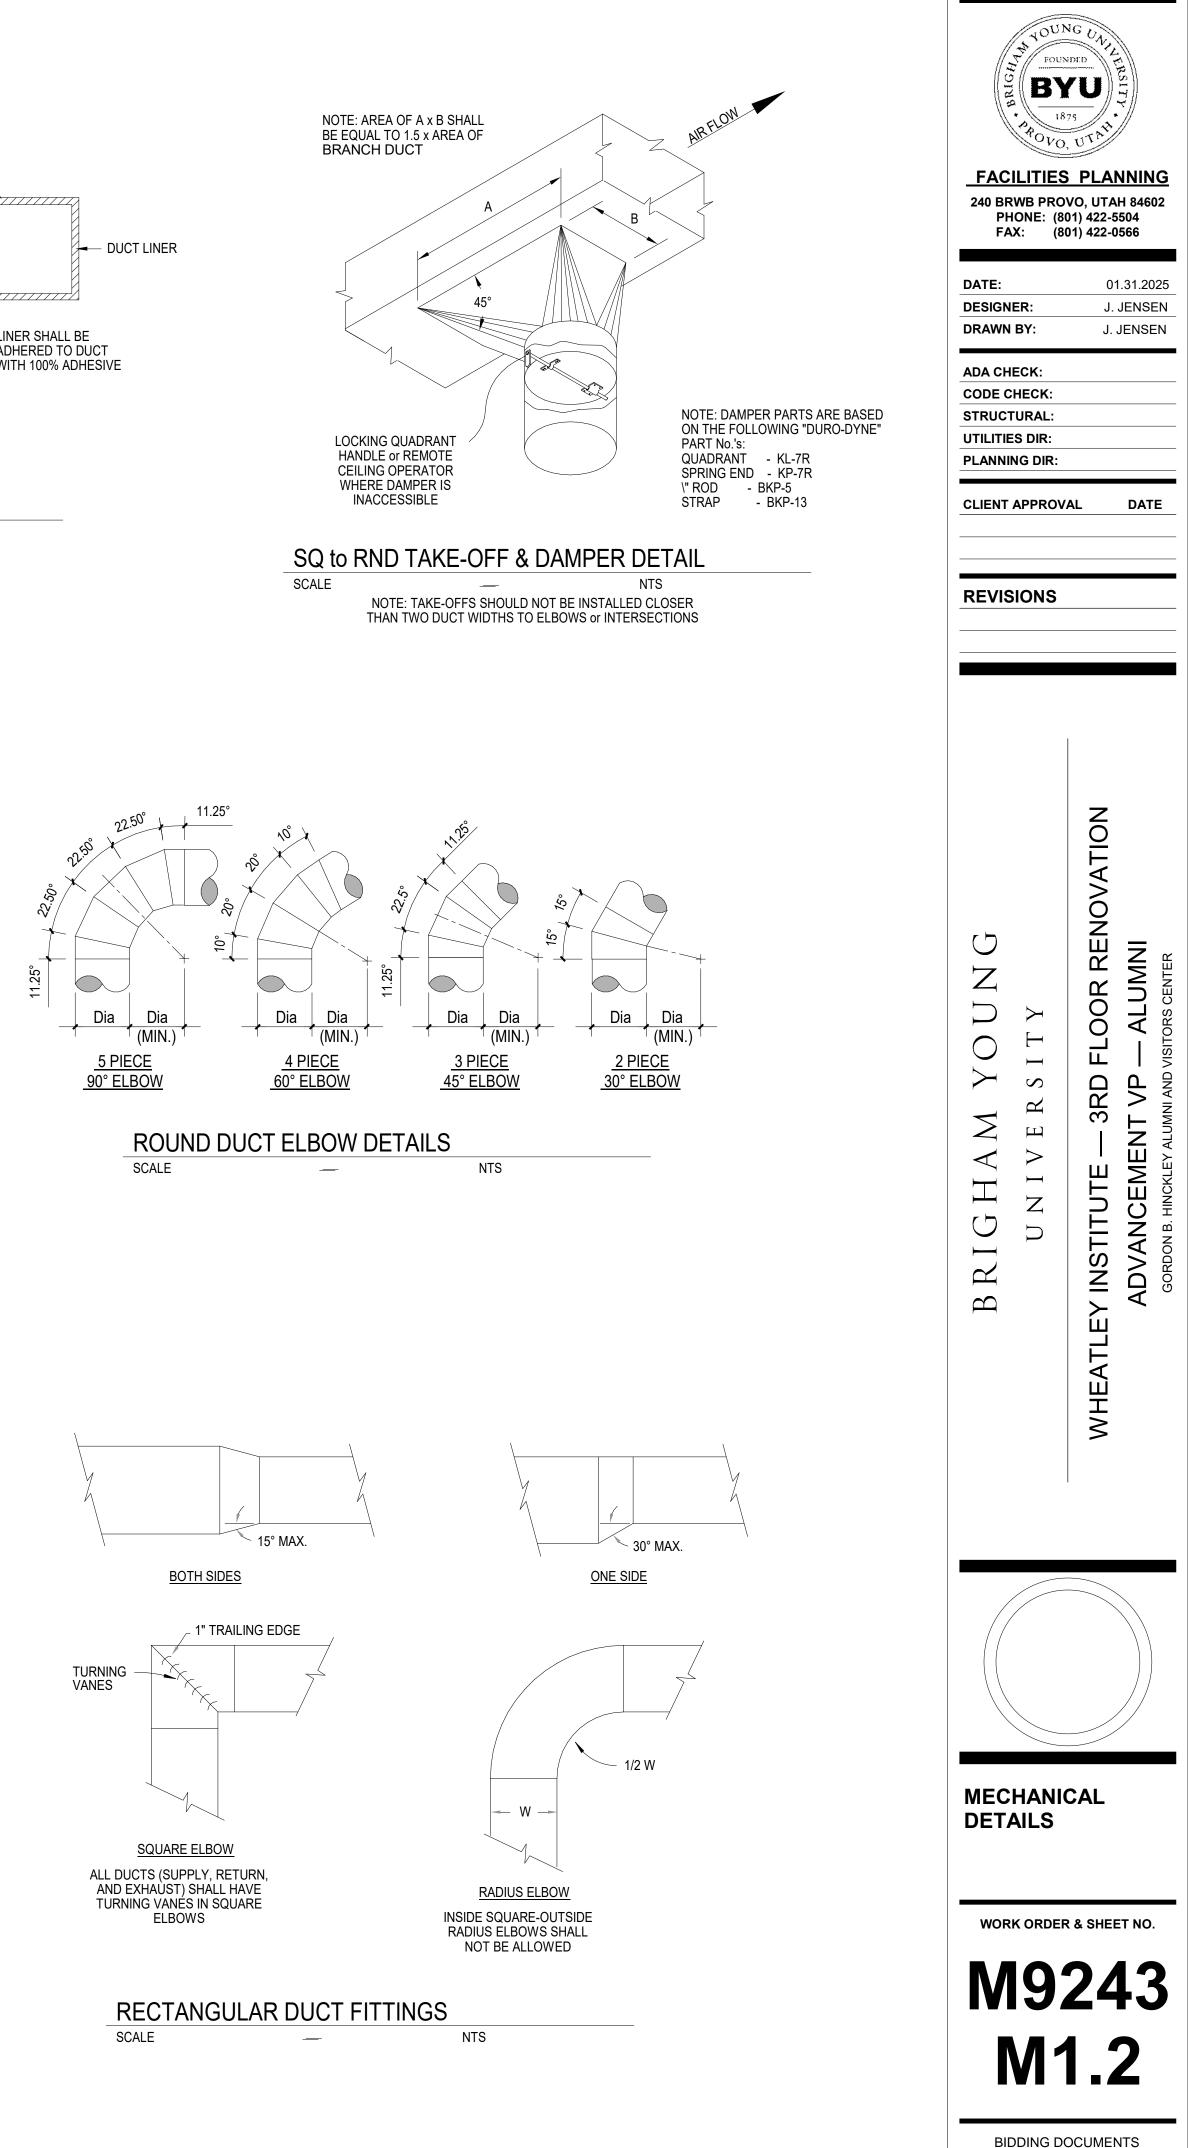


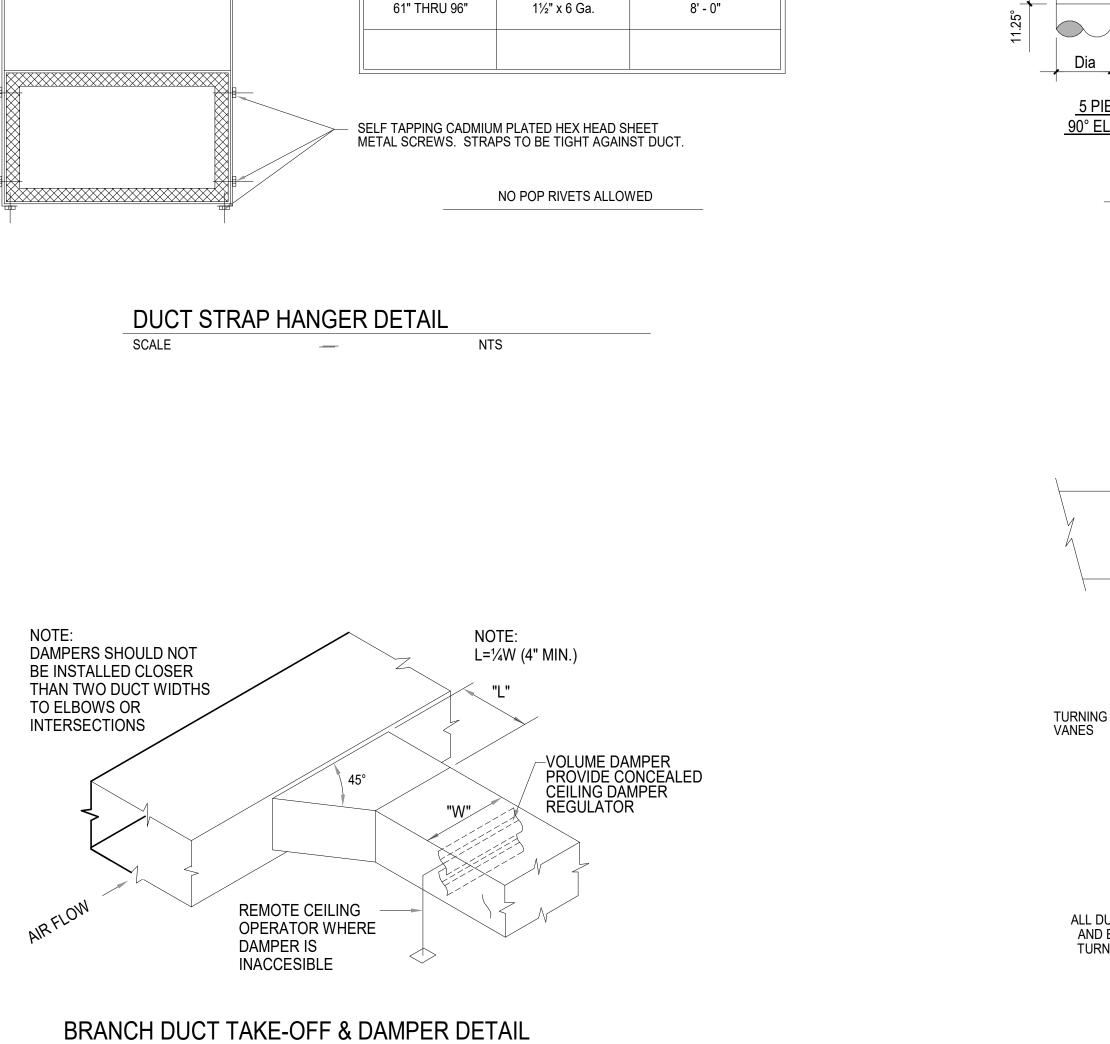




NEW POWER PLAN - 3RD FLOOR SOUTH SCALE: 1/8" = 1'-0"

SCALE: 1/8" = 1'-0"

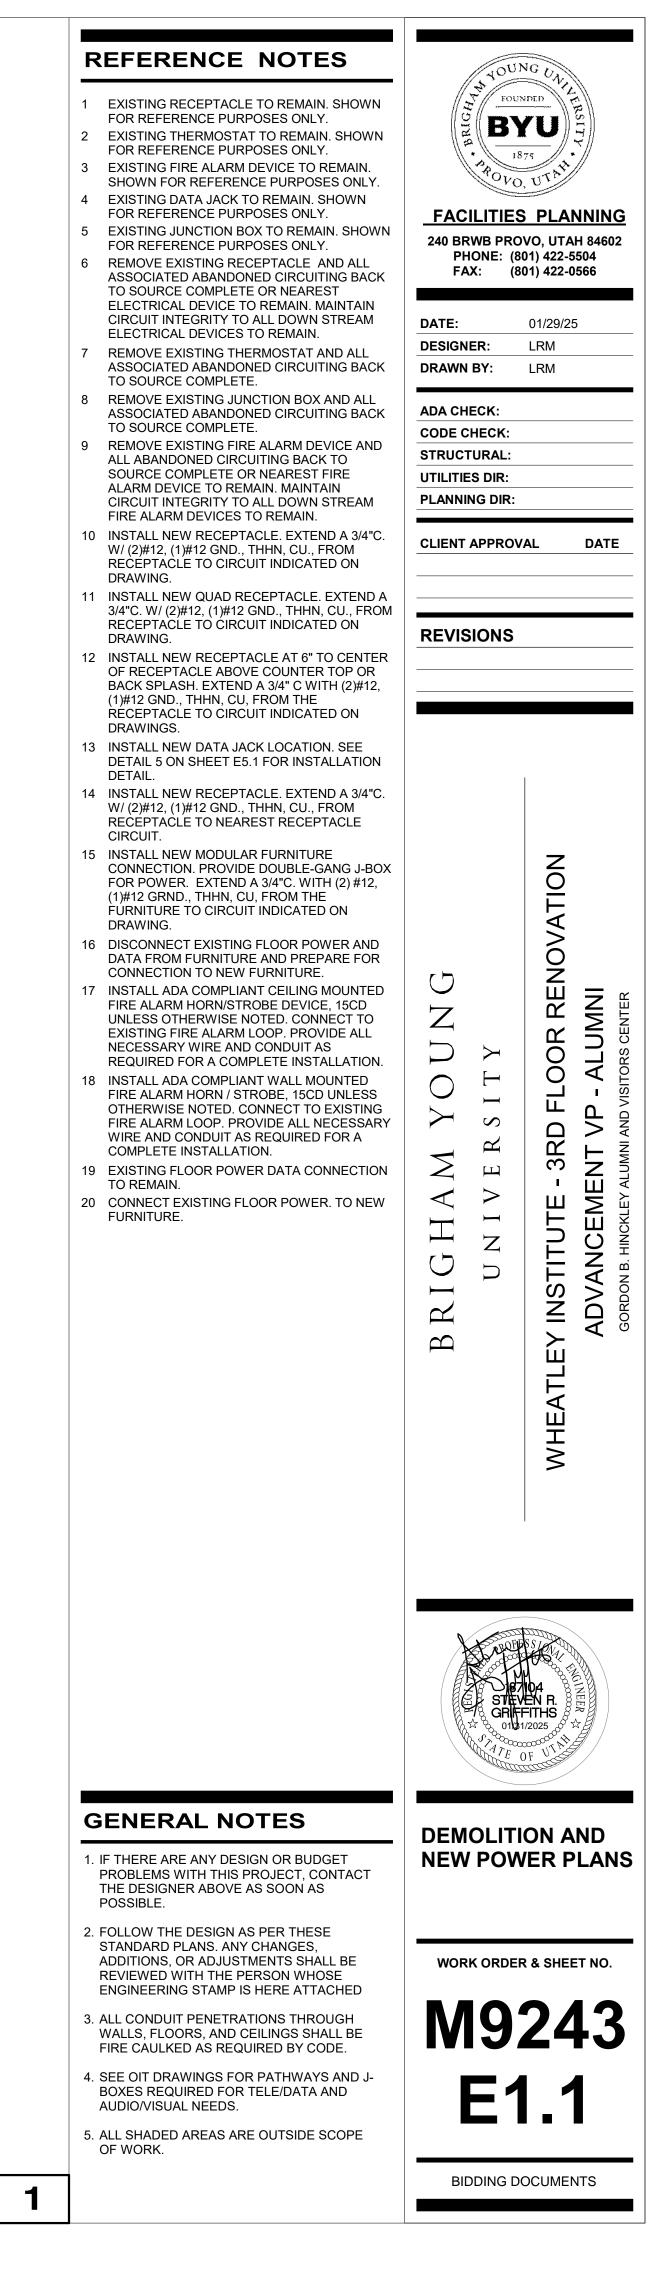



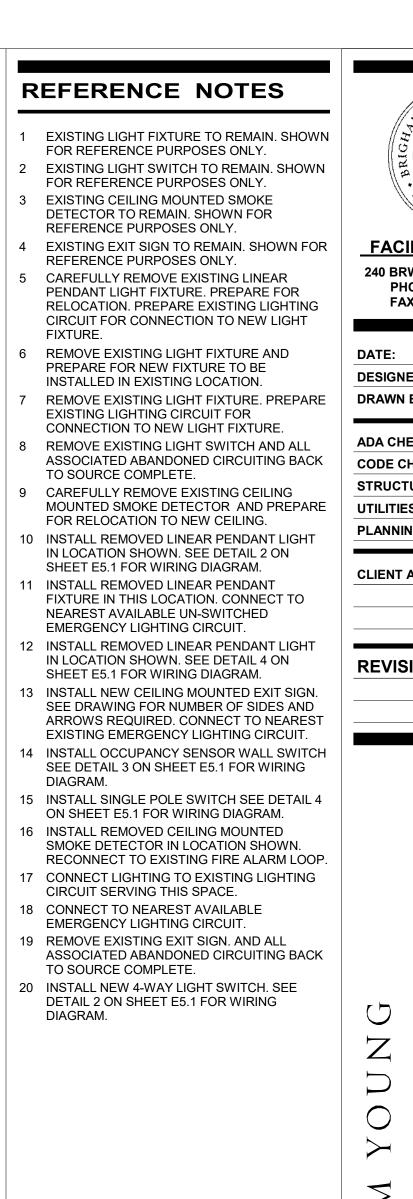

240 BR PH FA DATE: DESIGN DRAWN ADA CH CODE C STRUCT UTILITIE PLANNII	ER: BY: ECK: HECK: URAL: S DIR: NG DIR: APPROV	VO, UTA 01) 422-5 01) 422-0 01/29/2 LRM LRM	H 84602 5504 9566				
BRIGHAM YOUNG	UNIVERSITY	WHEATLEY INSTITUTE - 3RD FLOOR RENOVATION					
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5. ALL SHADED AREAS ARE OUTSIDE SCOPE OF WORK.

AUDIO/VISUAL NEEDS.

-

4. SEE OIT DRAWINGS FOR PATHWAYS AND J-BOXES REQUIRED FOR TELE/DATA AND

**GENERAL NOTES** 


POSSIBLE.


1. IF THERE ARE ANY DESIGN OR BUDGET PROBLEMS WITH THIS PROJECT, CONTACT THE DESIGNER ABOVE AS SOON AS

STANDARD PLANS. ANY CHANGES, ADDITIONS, OR ADJUSTMENTS SHALL BE REVIEWED WITH THE PERSON WHOSE ENGINEERING STAMP IS HERE ATTACHED

3. ALL CONDUIT PENETRATIONS THROUGH WALLS, FLOORS, AND CEILINGS SHALL BE FIRE CAULKED AS REQUIRED BY CODE.


2. FOLLOW THE DESIGN AS PER THESE

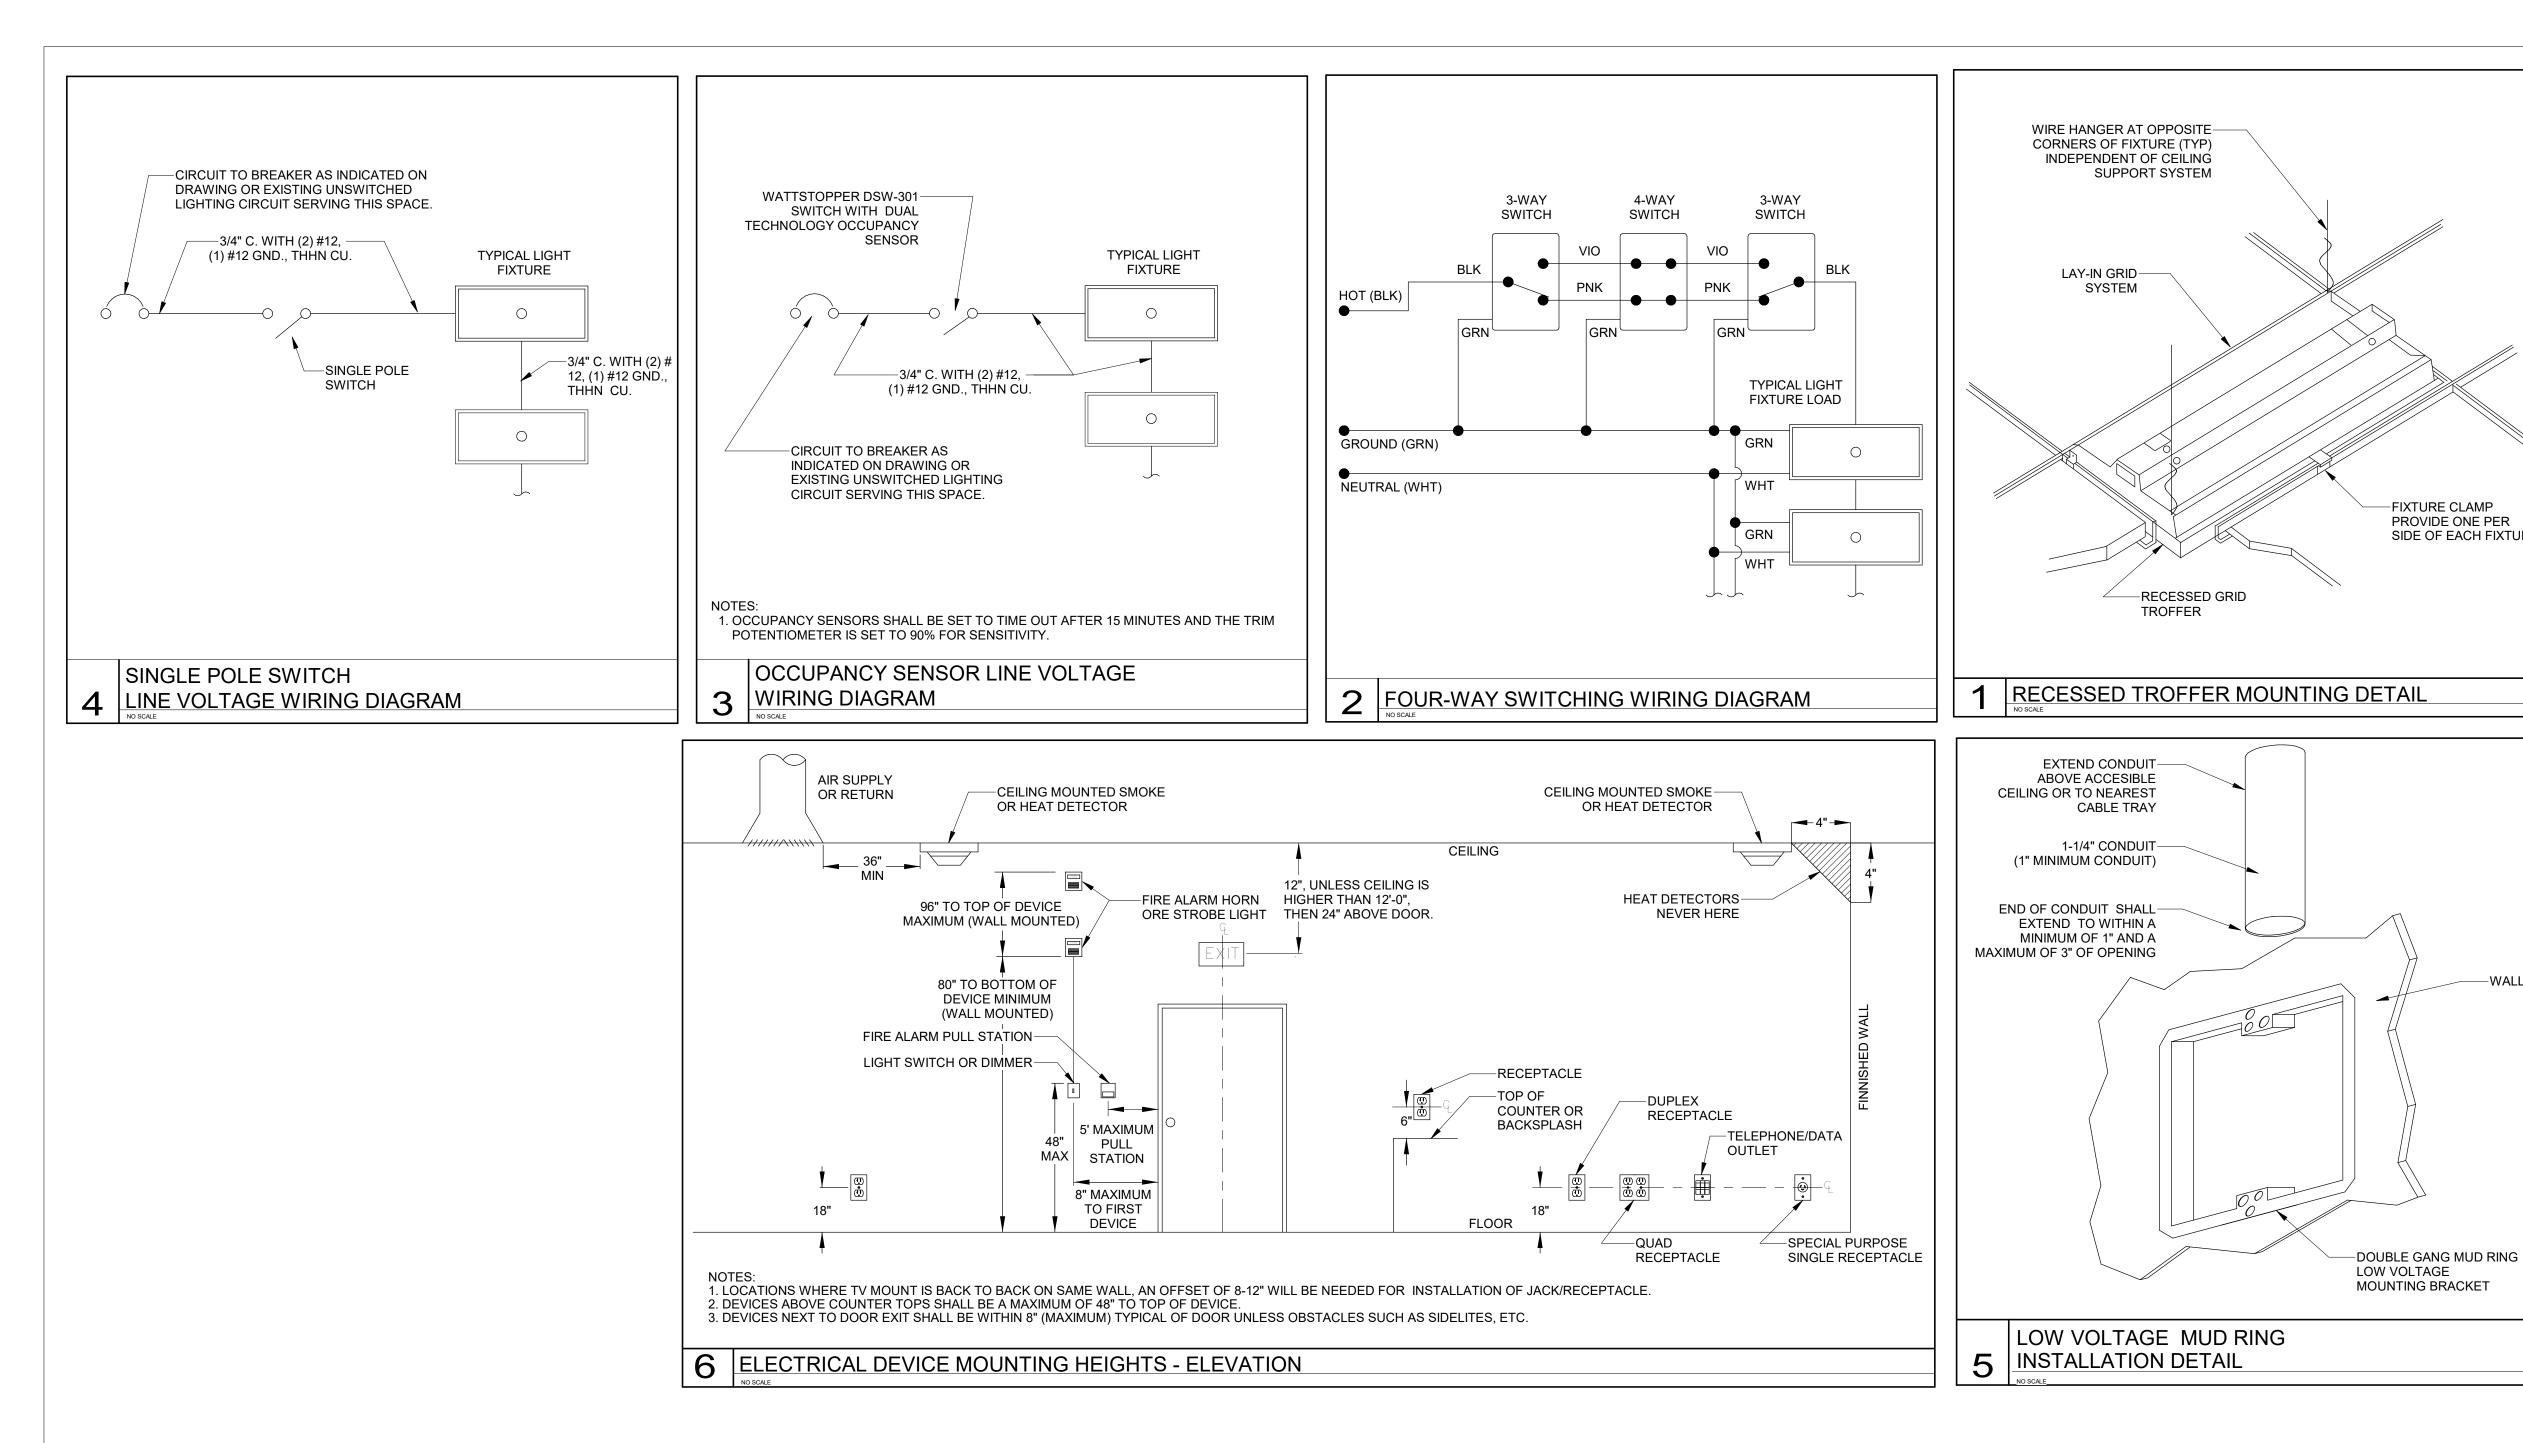

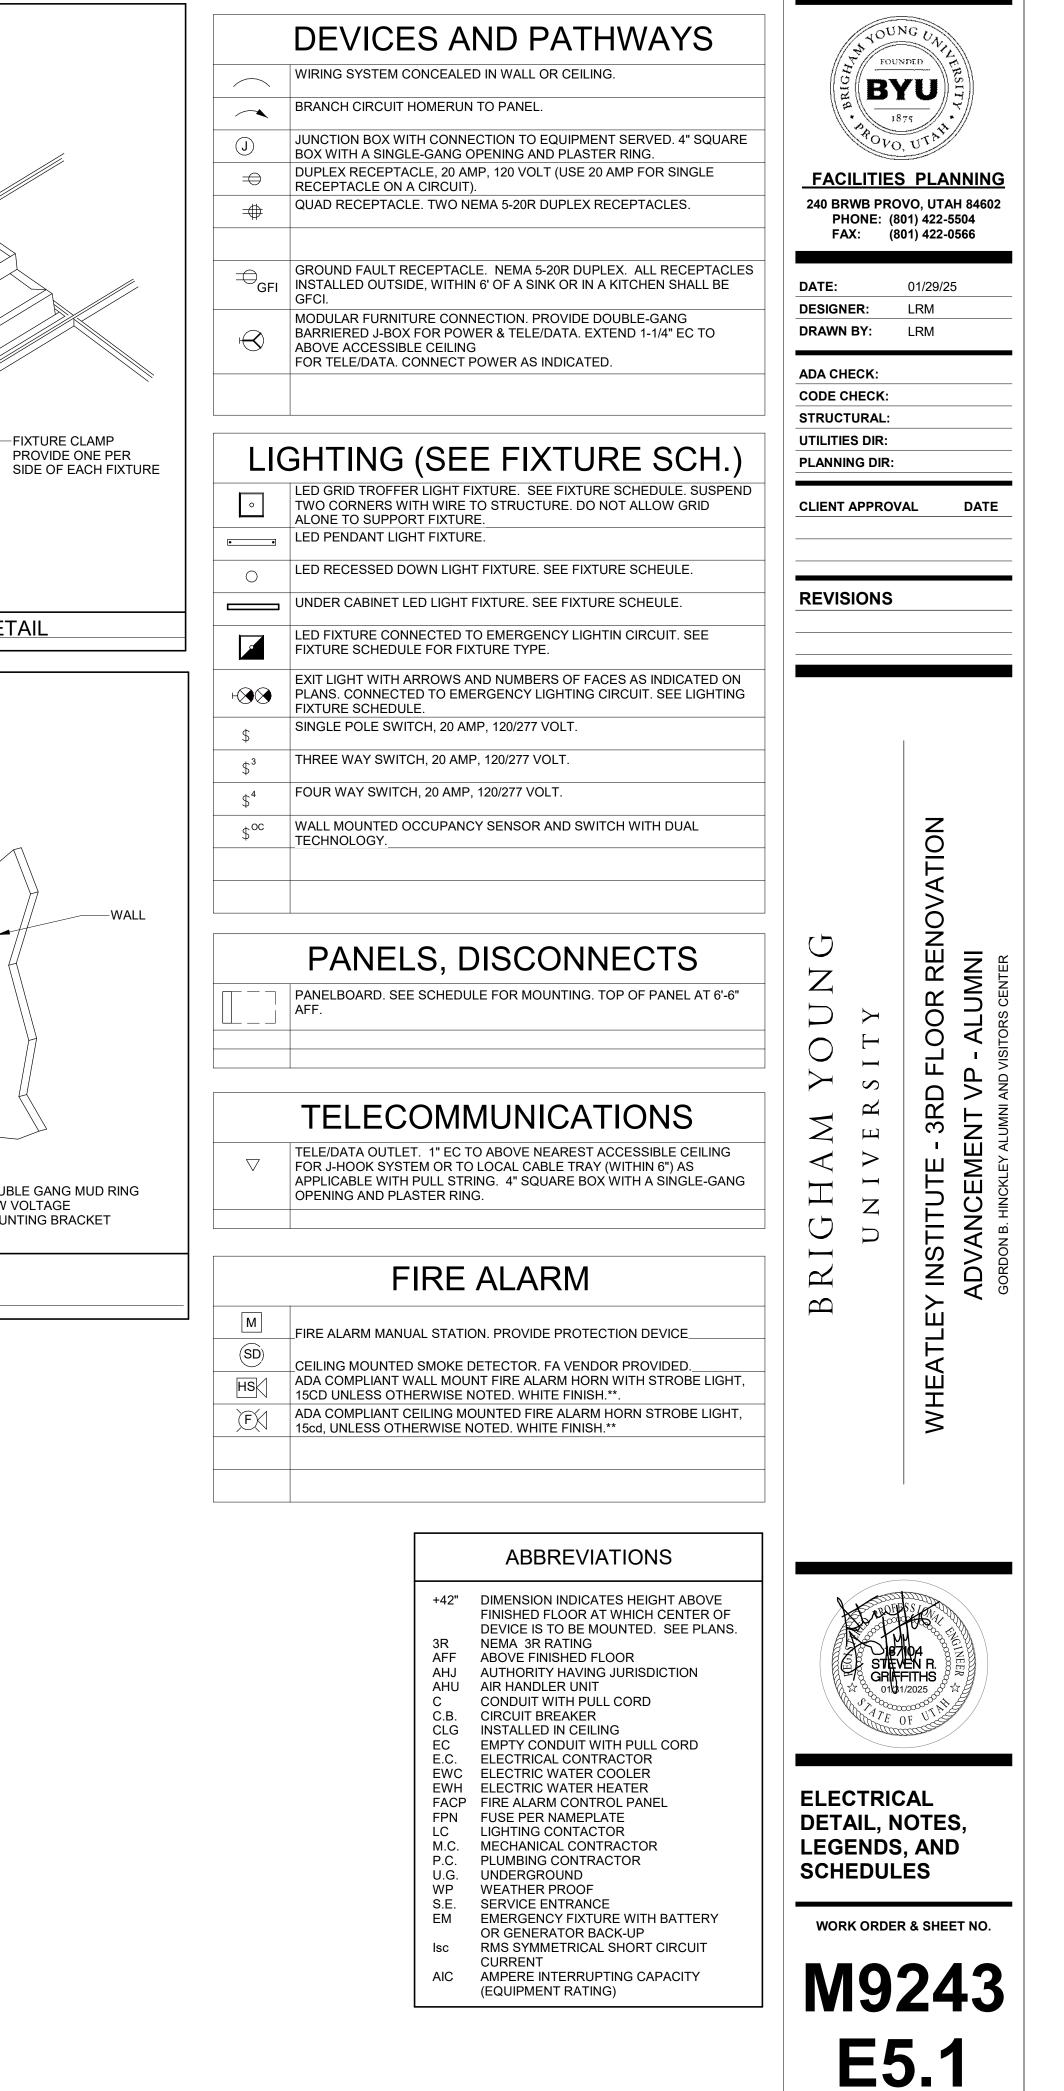



	PANEL SCHEDULE "3LC"																					
	VOLTAGE: 208 Y/ 120 VOLTS BUS RATI					•	•		225			F	REMAR	RKS:	EXISTING PANEL RM 331							
MOUNTING: SURFACE PHASE: 3 MAIN LUGS ONLY																						
	OSURE:				WI	RE:	4						AMPS (F		· · · · · · · · · · · · · · · · · · ·	1997						
CIR	CUITE	REA	<u>KER</u>			FEED	ER	СКТ	. LOAD	LOA	D/PHASE	(VA)	CKT. L	OAD	F	EEDE	R		CIR		BREA	KER
No.	AMPS	POLE	E MOD.	CIRCUIT NAME	c	WIRE	GRD	DEMAND FACTOR	WATTS	ØA	ØB	øc	WATTS	DEMAND FACTOR	GRD	WIRI	EC		MOD.	POLE	AMPS	No.
1	20	1	~	EXTG RECEPT. RM 327A	3⁄4"	#12	#12	1.00	900	1,800			900	1.00	#12	#12	3/4"	EXTG RECEPT, HALL 1 S STAIRS	~	1	20	2
3	20	1	-	EXTG RECEPT. RM 327B	3/4"	#12	#12	1.00	900		1,800		900	1.00	#12	#12	3⁄4"	EXTG REEPT, RM HALL / 338	-	1	20	4
5	20	1	-	EXTG RECEPT. RM 384	3/4"	#12	#12	1.00	900			1,800	900	1.00	#12	#12	3⁄4"	EXTG REEPT. RM HALL / 331	-	1	20	6
7	20	1	-	EXTG RECEPT. RM 386	3/4"	#12	#12	1.00	900	1,620			720	1.00	#12	#12	3⁄4"	EXTG STAIRS, RM 323		1	20	8
9	20	1	] -	EXTG RECEPT. RM 384	3/4"	#12	#12	1.00	900		1,800		900	1.00	#12	#12	3⁄4"	EXTG RECEPT. RM 394-396	-	1	20	10
11	20	1	-	EXTG RECEPT. RM 382	3/4"	#12	#12	1.00	900			1,800	900	1.00	#12	#12	3⁄4"	EXTG RECEPT. RM 394-396	-	1	20	12
13	20	1	-	EXTG RECEPT. RM 384	3/4"	#12	#12	1.00	900	1,800			900	1.00	#12	#12	3⁄4"	EXTG RECEPT. RM 394-396	-	1	20	14
15	20	1	-	EXTG RECEPT. WEST OFFICE	3/4"	#12	#12	1.00	900		2,000		1,100	1.00	#12	#12	3⁄4"	EXTG MICROWAVE BRK RM	-	1	20	16
17	20	1	**	EXTG RECEPT. RM 378	3/4"	#12	#12	1.00	900			1,080	180	1.00	#12	#12	3/4"	EXTG VENDING MACHINE RECEPT.		1	20	18
19	20	1	-	EXTG RECEPT, RR MEN'S	3/4"	#12	#12	1.00	360	540			180	1.00	#12	#12	3⁄4"	EXTG VENDING MACHINE RECEPT.	-	1	20	20
21	20	1	<b>-</b>	EXTG RECEPT. RR WOMEN'S	3/4"	#12	#12	1.00	360		720		360	1.00	#12	#12	3⁄4"	EXTG RECEPT. COUNTER GFCI	-	1	20	22
23	20	1	-	EXTG RECEPT. BREAK ROOM GFCI	3/4"	#12	#12	1.00	540			1,440	900	1.00	#12	#12	3⁄4"	EXTG REFRIGERATOR RECEPT.	-	1	20	24
25	20	1	-	EXTG RECEPT. RM 330	3/4"	#12	#12	1.00	900	1,440	1		540	1.00	#12	#12	3⁄4"	EXTG RECEPT BRK RM	-	1	20	26
27	20	1		EXTG RECEPT. RM 330	3/4"		#12		900		1,980		1,080	1.00	#12			NEW RECEPT, RM 342-5, 6	- 1	1	20	28
29	20	1	-	EXTG RECEPT, RM 330	3/4"	#12	#12	1.00	900			1,980	1,080	1.00	#12	#12	3/4"	NEW RECEPT. RM 342-7, 8	-	1	20	30
31	20	1	-	EXTG RECEPT. RM 330	3/4"	#12	#12	1.00	900	2,000			1,100	1.00	#12	#12	3⁄4"	EXTG MICROWAVE BRK RM	-	1	20	32
33	20	1		EXTG RECEPT, RM 379	3/4"	#12	#12	1.00	900		1,980		1,080	1.00	#12	#12	3/4"	NEW RECEPT. RM 342-9, 10	-	1	20	34
35	20	1	-	EXTG DRINKING FOUNTAIN GFCI	3⁄4"	#12	#12	1.00	1,000			1,900	900	1.00	#12	#12	3/4"	NEW RECEPT., FURN. CONN. RM 342	-	1	20	36
37	20	1		EXTG RECEPT. SOUTH WEST GFCI	3/4"	#12	#12	1.00	900	4,900			4,000	1.00	#10	#8	3⁄4"	EXTG RANGE		2	50	38
39	20	1	-	NEW COUNTER RECEPT. RM 342	3/4"	#12	#12	1.00	540		4,540		4,000	1.00	-	#8	-	-	-	-	-	40
41	20	1	-	NEW RECEPT. RM 342-1,2,3,4	3/4"	#12	#12	1.00	1,080			1,980	900	1.00	#12	#12	3⁄4"	EXTG REFRIGERATOR RECEPT.	-	1	20	42
Ν	OTES :				-			-														
1.	CIRCU	TS SF	HOWN	IN BOLD ARE NEW OR HAVE BEEN MODIFIED.						ØA	ØB	ØC	TOTALS	]								
										14,100	14,820	11,980	40,900	CONN	IECTE	D LOA	D (V	A)				
2.	E.C. SH	HALL F	PROVI	DE UPDATED DOOR MOUNTED PANEL SCHEDI	JLE.						J		าร์การระบบการที่การการการการการการการการการการการการการก	CONN								·· .
										0	0	0	0					JUSTMENTS (VA)				· · ·
3.	ABBRE	VIATIO	ON EX	TG MEANS EXISTING.						14,100	14,820	11,980	40,900						د د ا مربع مربع	t te caett aus	1997 - 1997 - 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BYU LIGHTING FIXTURE SCHEDULE												
FIXTURE	MANUFACTURER	FIXTURE CATALOG NUMBER		MPS	FIXT			FIXTURE DESCRIPTION	REMARKS			
NUMBER			ТҮРЕ	QTY.	VOLTS	WATTS	MOUNTING					
F1 F1E	PHILIPS LITHONIA METALUX SLG	2SBP3040L8CS-2-UN3-DIM CPX 2X2 AL07 SWW7 M4 22CTGS-L3C3 TPS 22 40 G1 FSK	LED	1	UNIV	37.3W	RECESSED GRID	2X2 LED FLAT PANEL RECESSED GRID TROFFER. 4000K COLOR TEMPERATURE				
F2E	LITHONIA SLG BLG SYLVANIA COOPER	CPX 2X4 ALO8 SWW7 TPS2435/45/55G2FSK LPX-24-CP4 PANELF3BSO45UNVD8699 24CGTS-L3C3	LED	1	UNV	50W .	RECESSED GRID	2X4 LED FLAT PANEL RECESSED GRID TROFFER. 4000K COLOR TEMPERATURE				
F3	SPECTRUM LIGTING	SGRTA6XT30L40KXWDS101/AR6755XTMWSO	LED	1	120V	34.6W	E CEUING	6" RETROFIT LED DOWN LIGHT FOR SLOPED CEILINGS. 3000LM / 4000K COLOR TEMP.				
F4	HALO LIGHTING	HU30SCT48P	LED	1	120V	21.4W	UNDER CABINET LIGHTING	24" LED UNDER CABINET LIGHT 4000K COLOR TEMPERATURE	PROVIDE ALL REQUIRED CABLES FOR A COMPLETE INSTALLATION.			
EX	DUAL LITE	SESGW (SINGLE FACE) SEDGW (DOUBLE FACE)	LED	2	UNIV .	2.1W	WALL / CEILING	WALL OR CEILING MOUNTED EXIT SIGN WITH SINGLE OR DOUBLE FACE LETTERING AND BREAK OUT CHEVRONS FOR DIRECTION ARROWS.	VERIFY NUMBER OF FACES AND ARROW TYPES WITH DRAWINGS.			

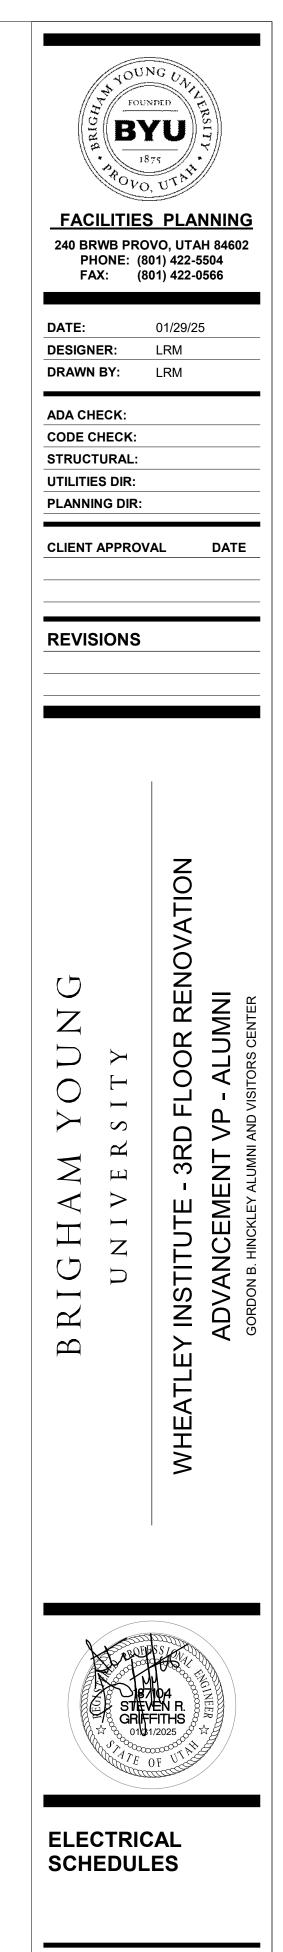


WORK ORDER & SHEET NO.




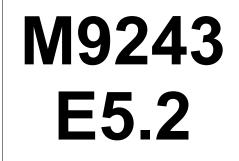

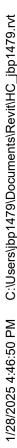

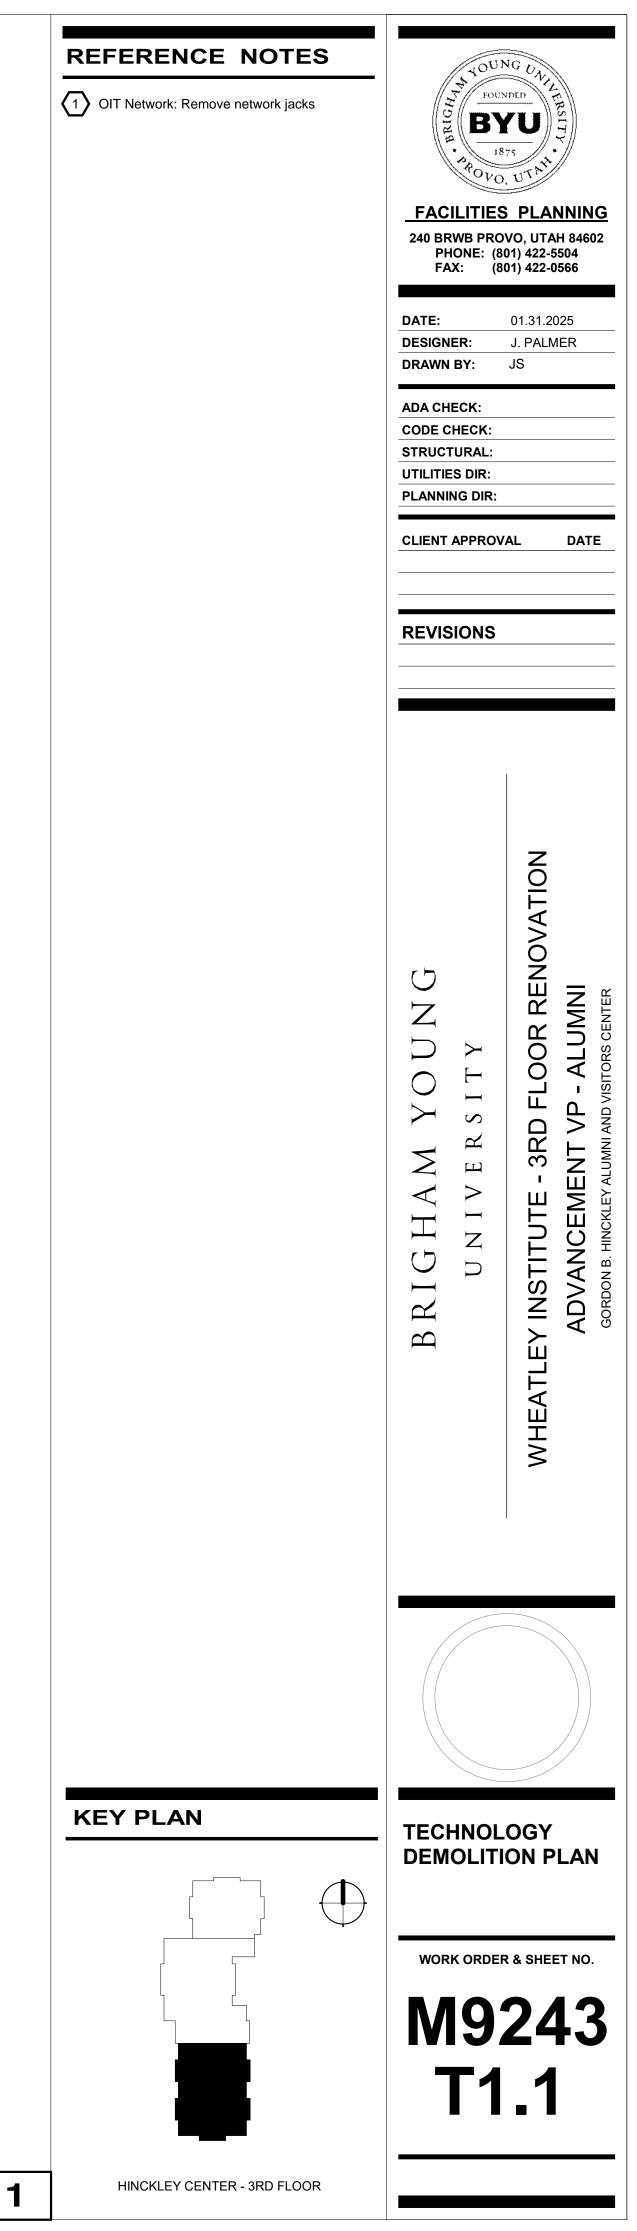



PLAN - 3RD FLOOR SOUTH	1
SCALE: 1/8" = 1'-0"	-

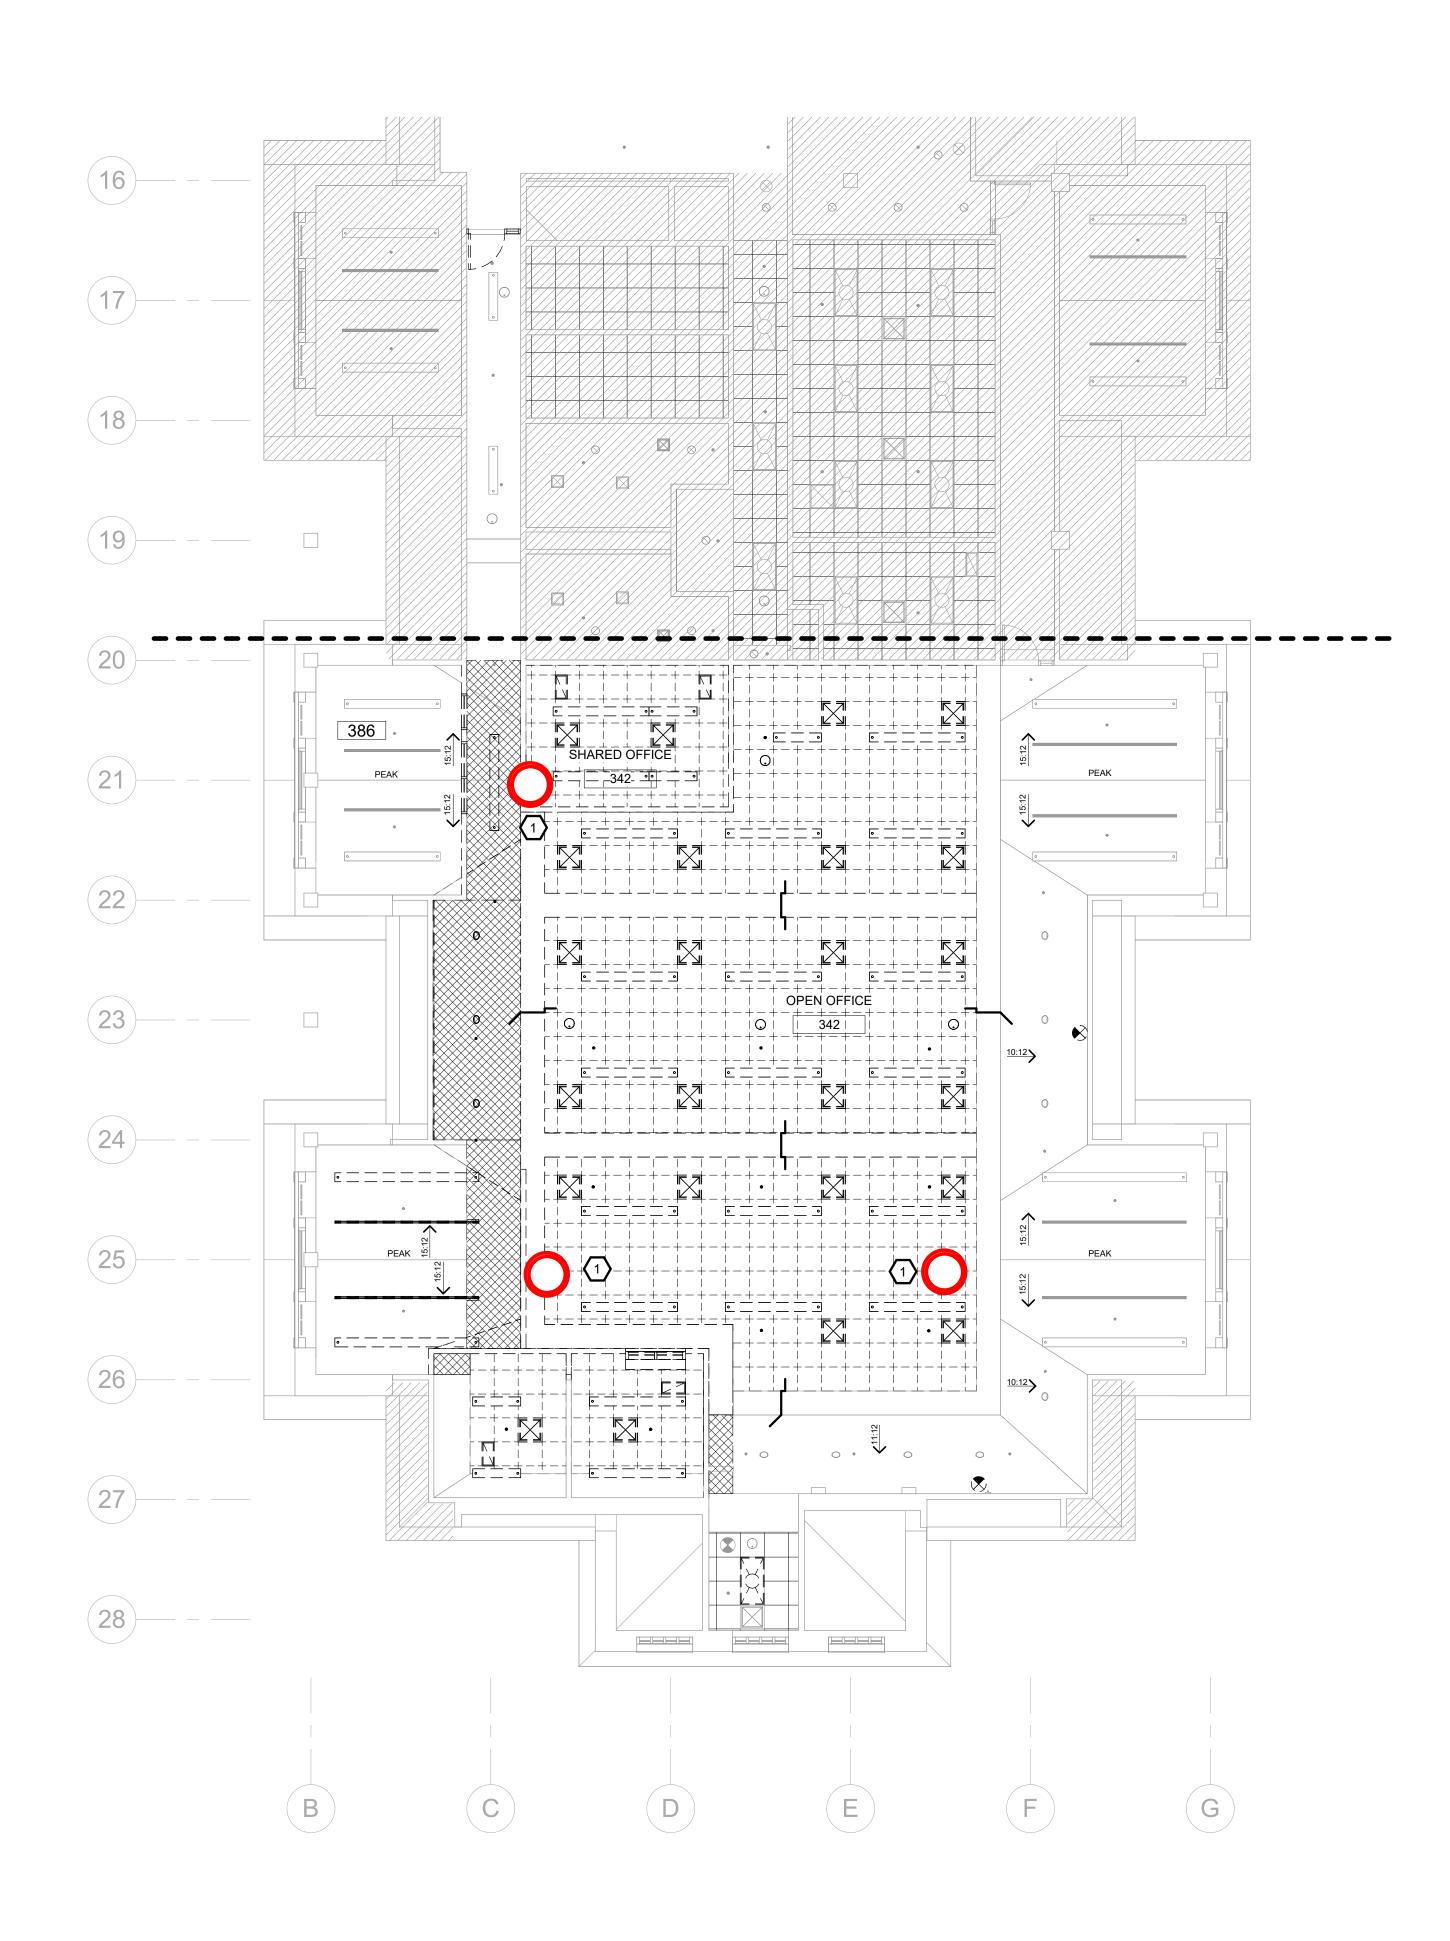

**REFERENCE NOTES** OUNG OIT Network: Temporarily remove wireless AP and associated jacks FOUNDED BYU FACILITIES PLANNING 240 BRWB PROVO, UTAH 84602 PHONE: (801) 422-5504 FAX: (801) 422-0566 DATE: 01.31.2025 DESIGNER: J. PALMER DRAWN BY: JS ADA CHECK: CODE CHECK: STRUCTURAL: UTILITIES DIR: PLANNING DIR: CLIENT APPROVAL DATE REVISIONS RENOVATION Ζ r  $\square$  $\frown$ μ  $\boldsymbol{\mathcal{S}}$ Ч  $\mathbf{\mathcal{L}}$ ΙVΕ AV (·) UEN -N N C WHEATLEY INST ADVA  $\mathbf{Z}$ В **KEY PLAN** TECHNOLOGY **DEMO CEILING** PLAN  $\bigcirc$ WORK ORDER & SHEET NO. **M9243 T1.2** HINCKLEY CENTER - 3RD FLOOR


PLAN - 3BD FLOOR SOUTH

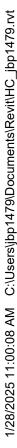

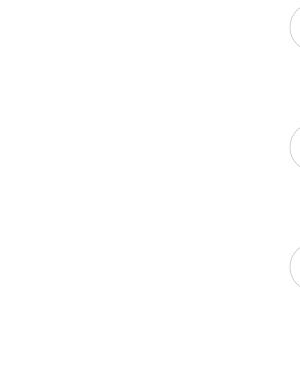



<section-header>         REFERENCE NOTES</section-header>	FACILITIES PLANNING         PHONE:         1875         1875         PACILITIES PLANNING         240 BRWB PROVO, UTAH 84602         PHONE:         (801) 422-5504         FAX:         (801) 422-5566         DATE:         DATE:         DATE:         J. PALMER         DRAWN BY:         JS         ADA CHECK:         CODE CHECK:         STRUCTURAL:         UTILITIES DIR:         PLANNING DIR:         CLIENT APPROVAL         DATE
	BRIGHAM YOUNG UNIVERSITY WHEATLEY INSTITUTE - 3RD FLOOR RENOVATION ADVANCEMENT VP - ALUMNI GORDAN HINCKLEY ALUMNIAND VISITORS CENTER
	Image: constraint of the state of

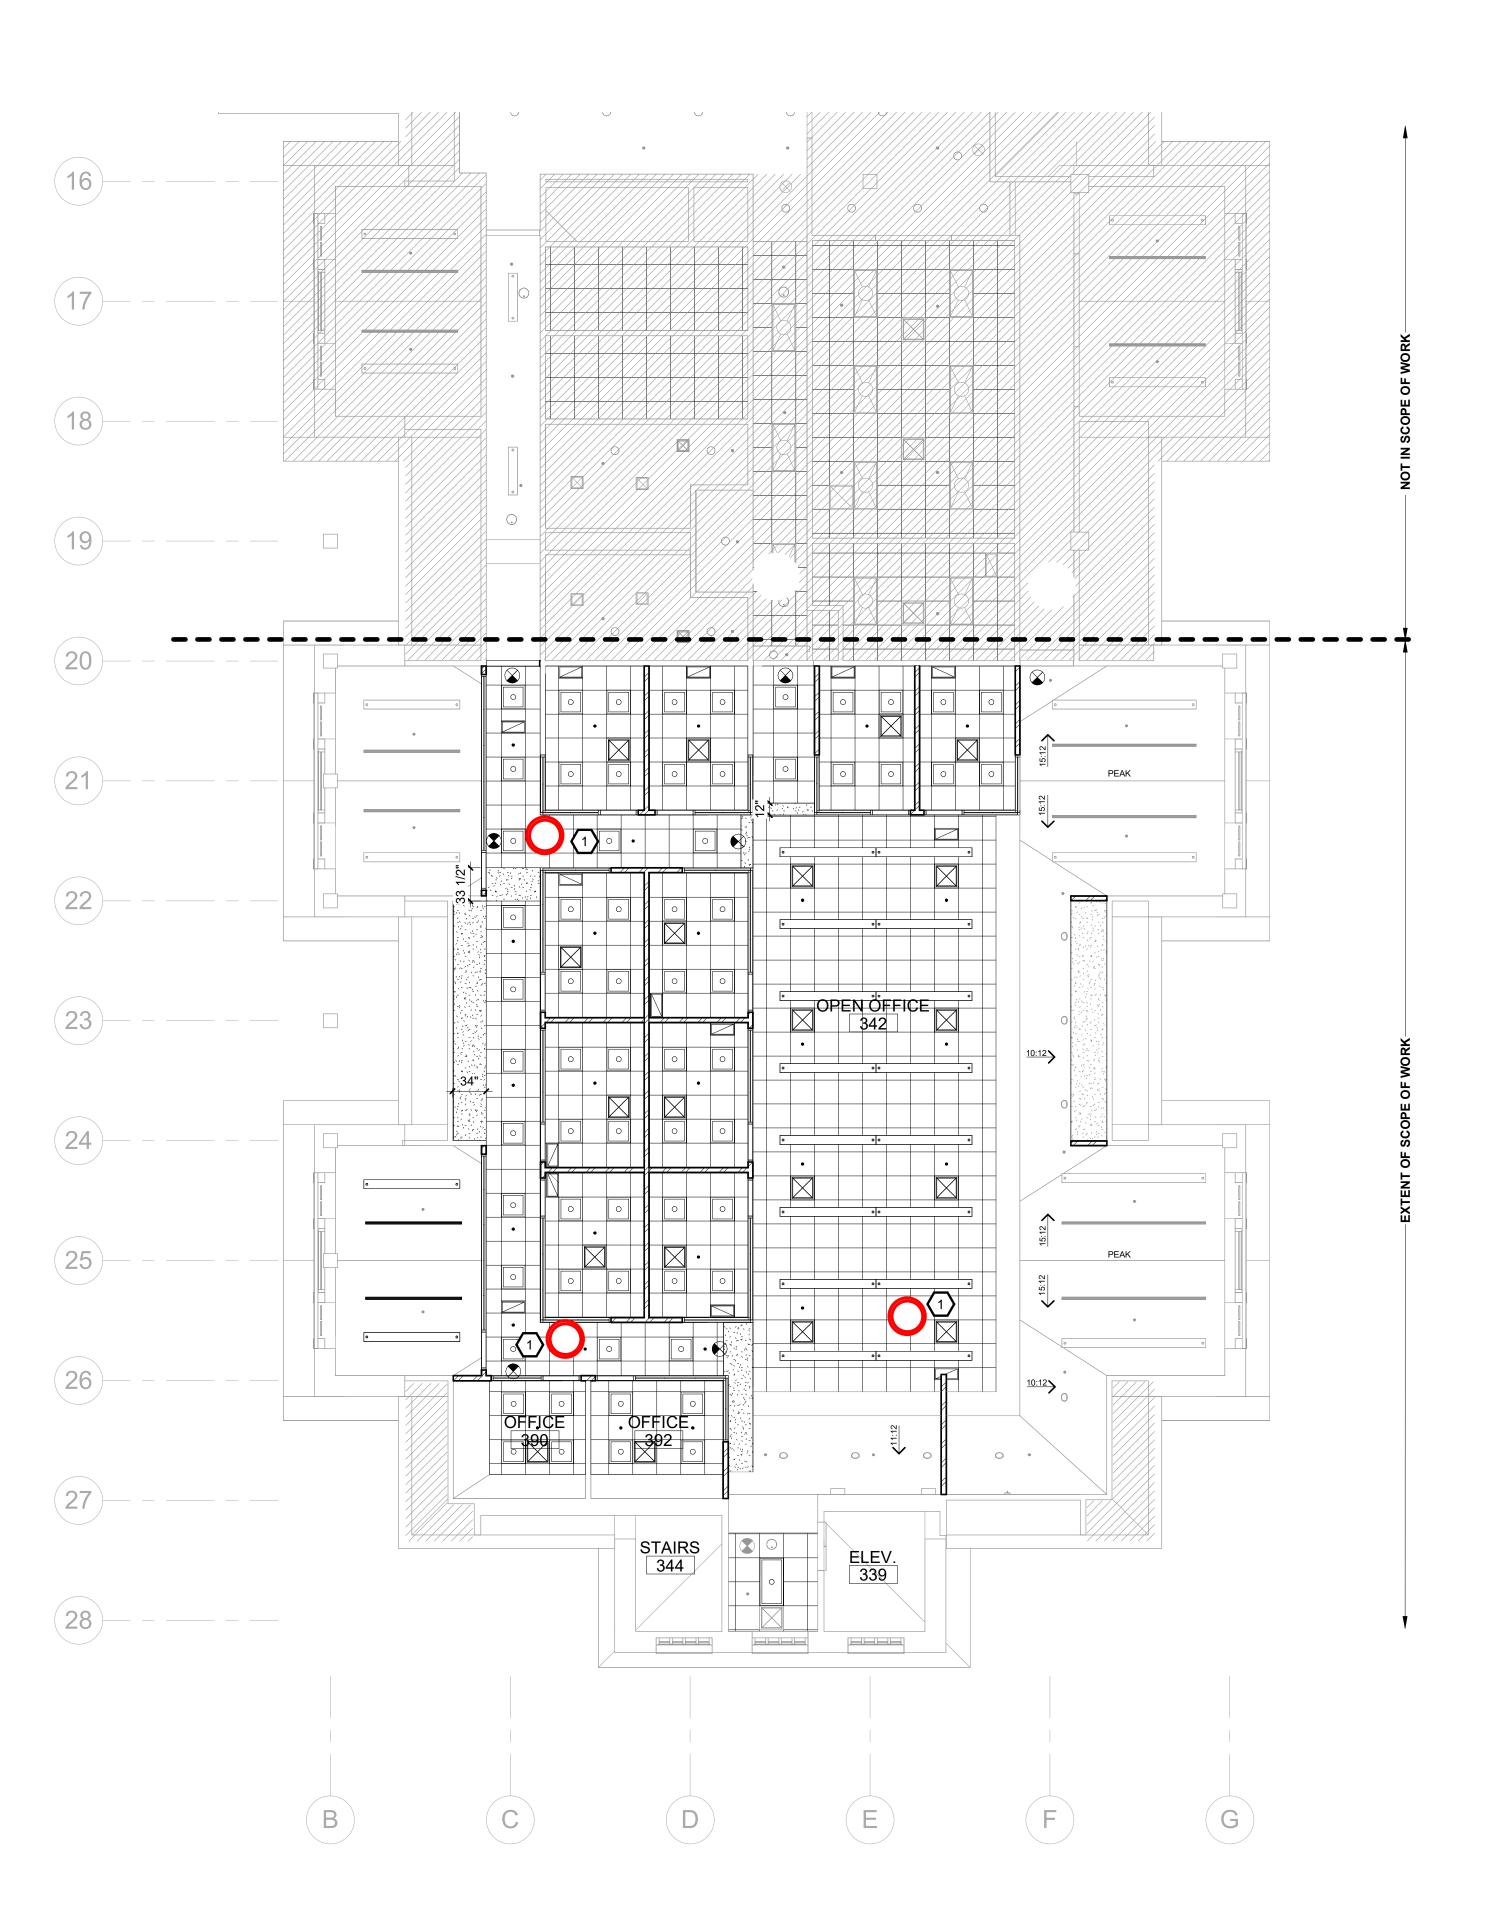

OT Network: Reinstall wireless AP and associated jacks	FACILITIES 240 BRWB PRO PHONE: (8	S PLANNING VO, UTAH 84602 01) 422-5504 01) 422-0566 01.31.2025 J. PALMER JS
	BRIGHAM YOUNG UNIVERSITY	WHEATLEY INSTITUTE - 3RD FLOOR RENOVATION ADVANCEMENT VP - ALUMNI GORDON B. HINCKLEY ALUMNI AND VISITORS CENTER
KEY PLAN	REFLECTI CEILING P WORK ORDER	

NEW CEILING PLAN - 3RD FLOOR SOUTH SCALE: 1/8" = 1'-0"