# SSL FINANCE OFFICE REMODEL

220 MORRIS AVE.
SOUTH SALT LAKE CITY UT 84115

OWNER



USER

CIVIL

2032 Lincoln Avenue Suite 102 Ogden, UT 84401

T: (385) 244-1140 carbonarchitects.us

PROJECT:

SSL FINANCE
OFFICE REMODEL

#### LANDSCAPE

220 MORRIS AVE. SOUTH SALT LAKE CITY UT 84115

DATE: PROJECT NO	09/08/23 1128-022
REVISION	DATE
REVISION	DAIL

#### **ARCHITECT**

CARBON ARCHITECTS
2032 LINCOLN AVE. STE 102
OGDEN, UT 84401
801-668-4241
CARBONARCHITECTS.US

ISSU	ED	
NO.	DATE	DESCRIPTION
1.		
2.		


STRUCTURAL



COVER SHEET

SCA



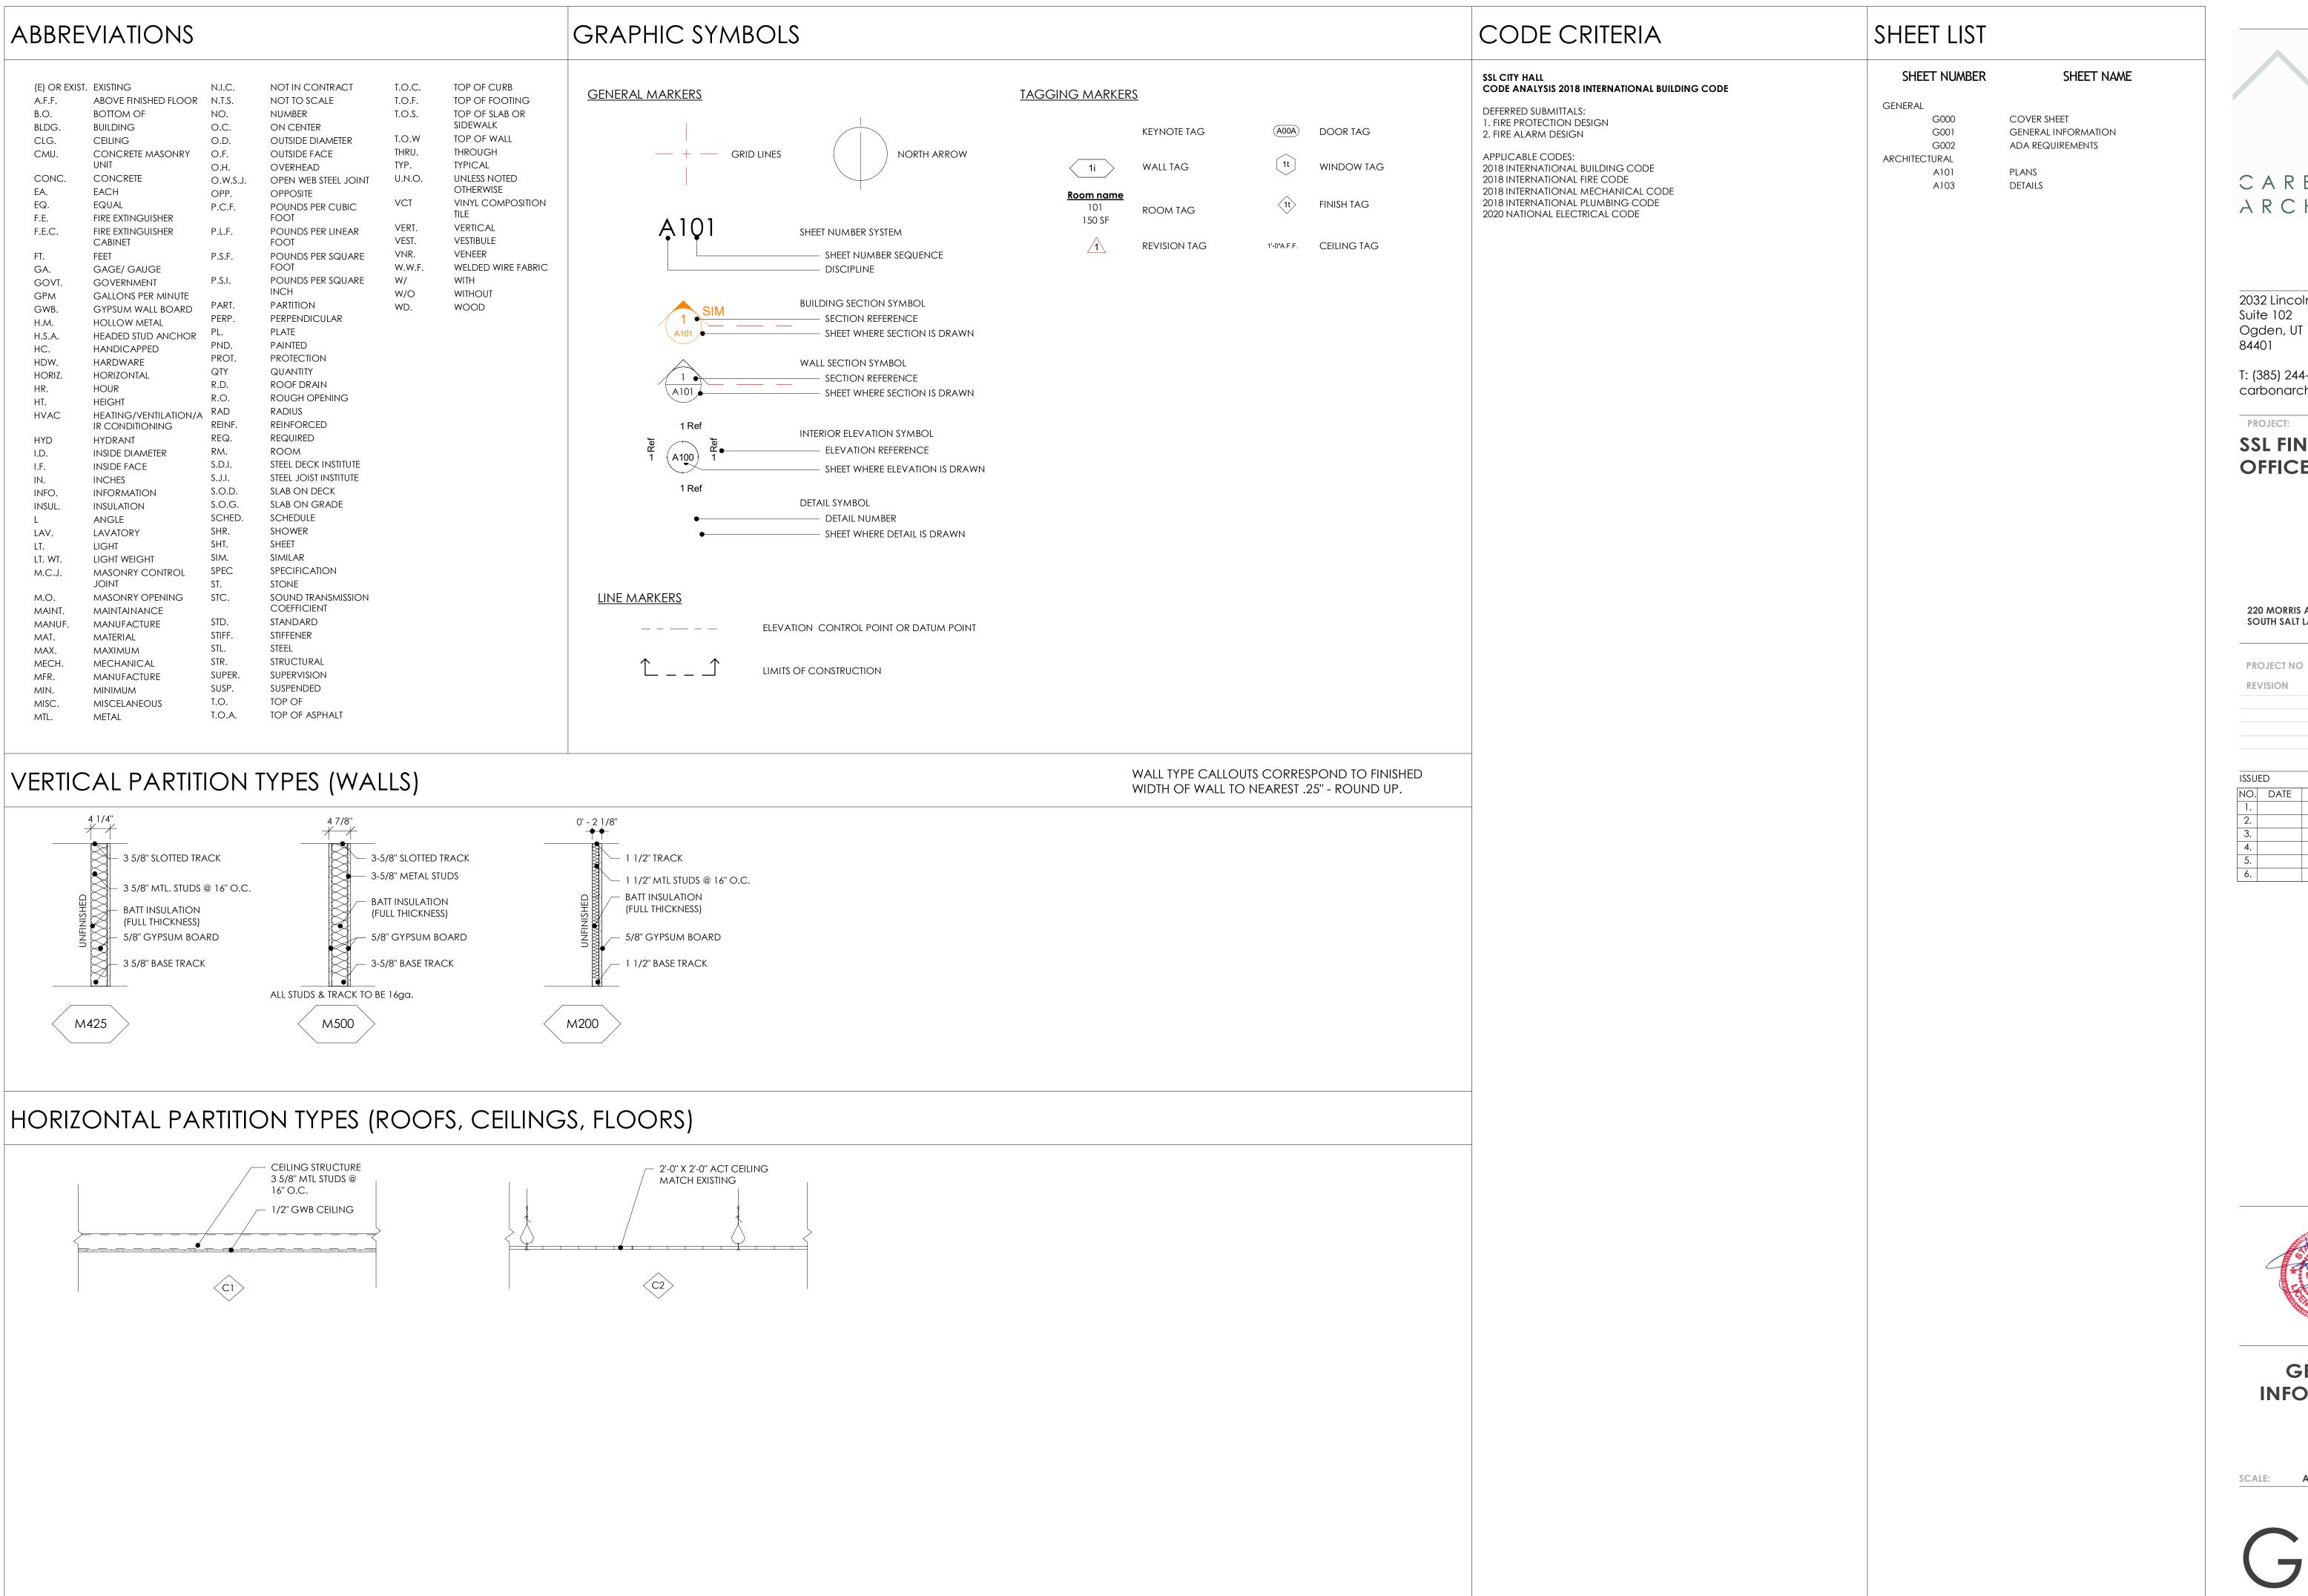



2032 Lincoln Avenue Suite 102 Ogden, UT 84401

T: (385) 244-1140 carbonarchitects.us

PROJECT:

**SSL FINANCE OFFICE REMODEL** 

220 MORRIS AVE. **SOUTH SALT LAKE CITY UT 84115** 

1128-022 REVISION DATE


NO. DATE DESCRIPTION




**GENERAL INFORMATION** 

SCALE: As indicated




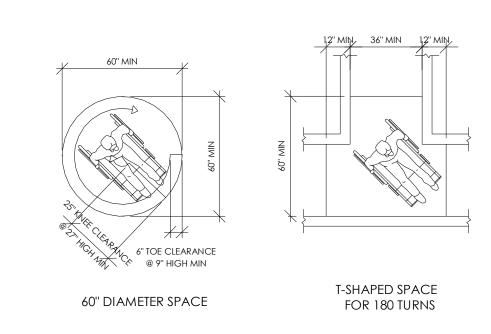

#### 304. WHEELCHAIR TURNING SPACE

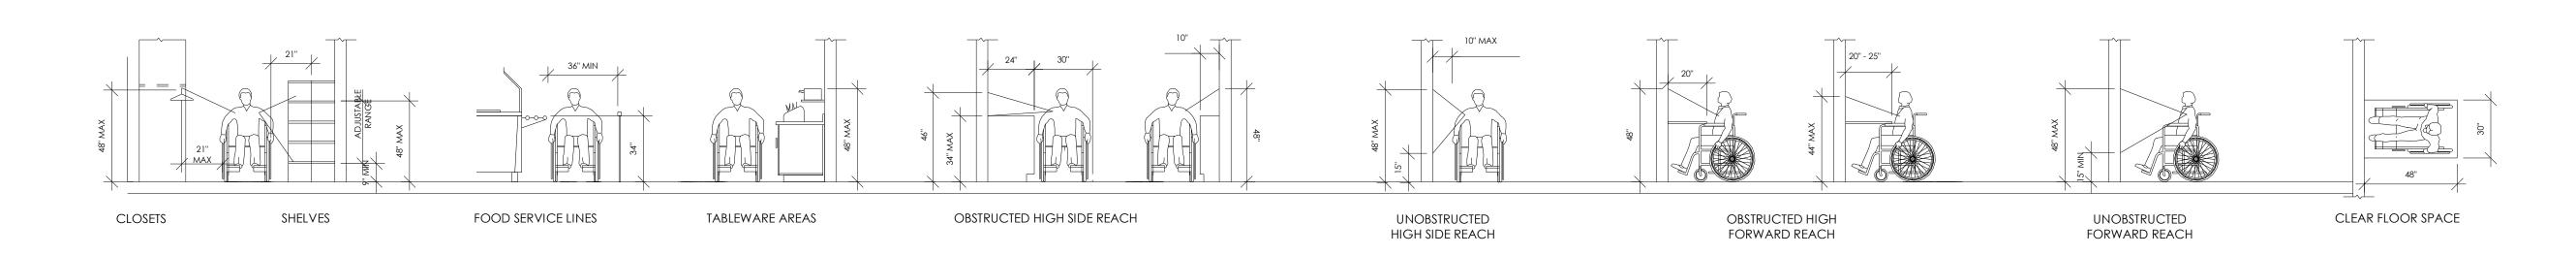


#### 308. REACH RANGES

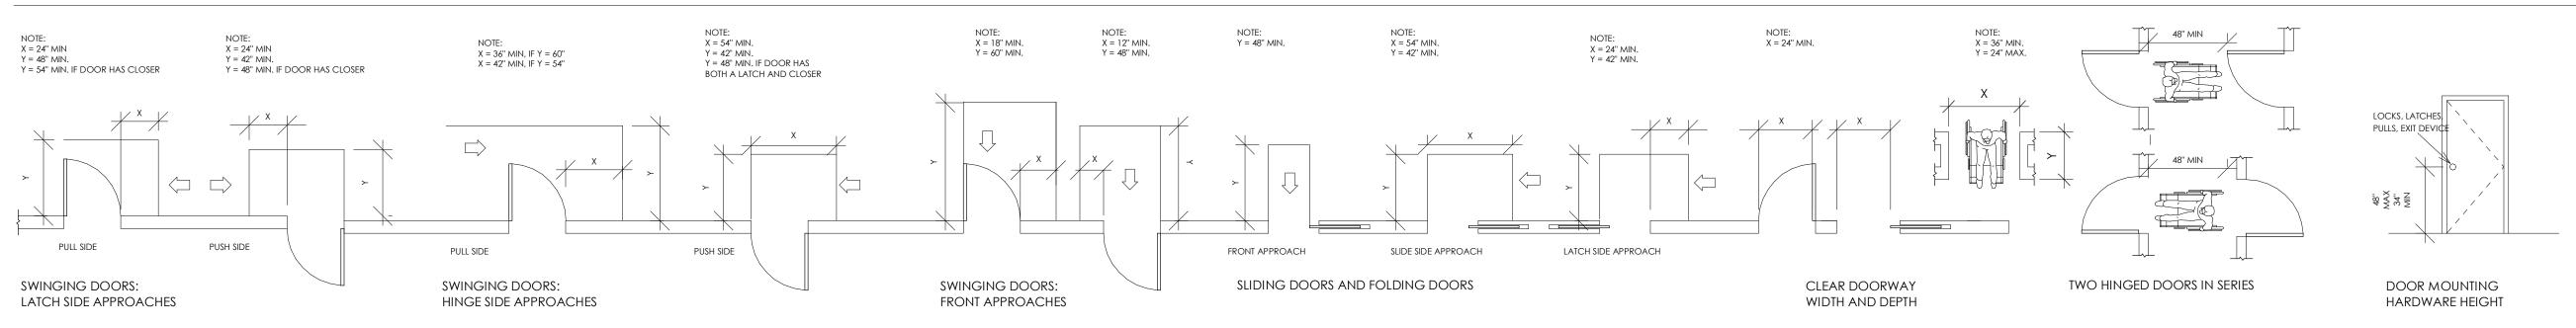


NOTE: ALL DOORS IN ALCOVES SHALL COMPLY WITH THE CLEARANCES FOR FRONT APPROACHES

#### 404. DOORS AND DOORWAYS

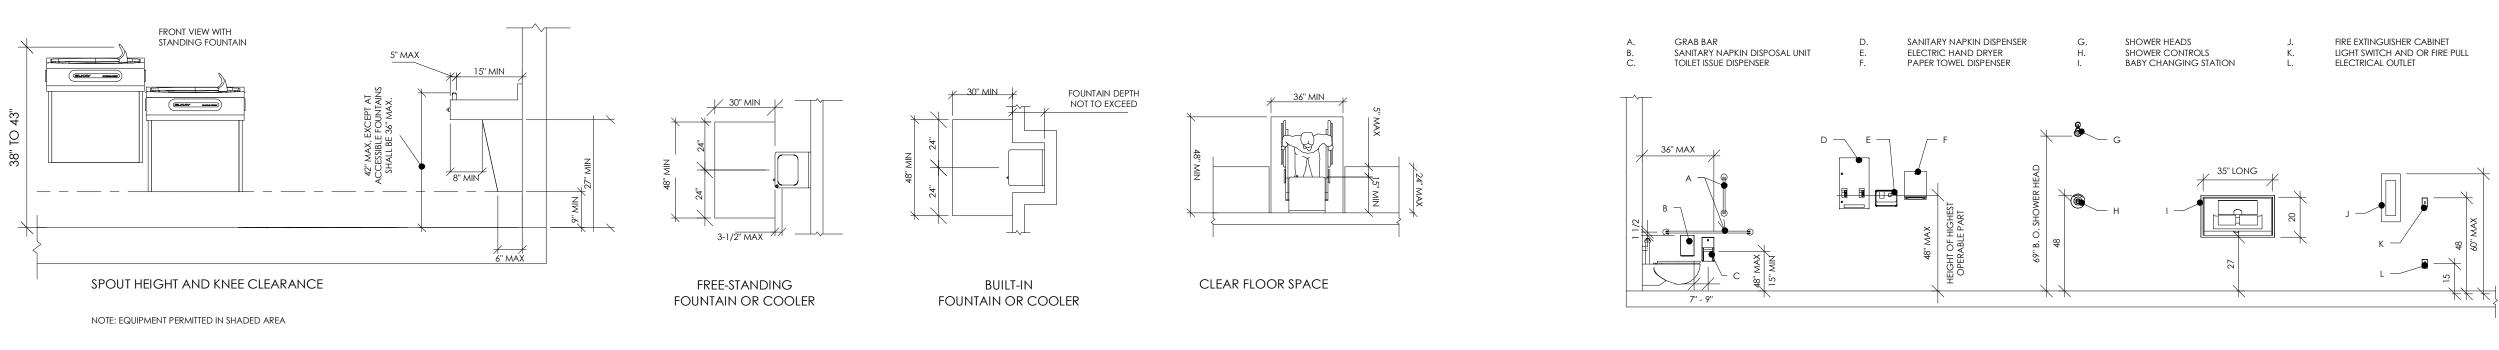

604.7 ACCESSORIES AND EQUIPMENT

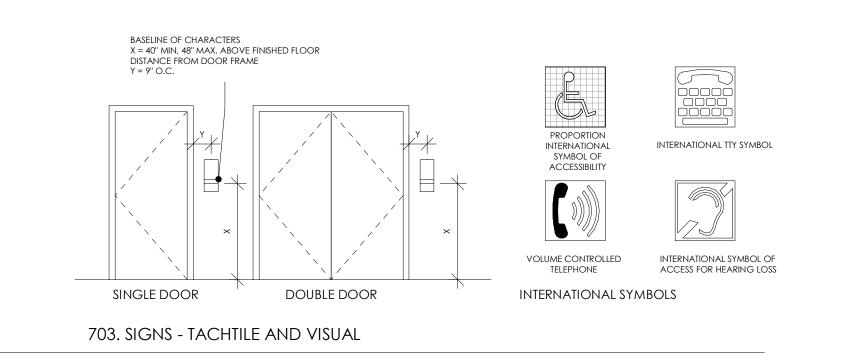



2032 Lincoln Avenue Suite 102 Ogden, UT 84401

T: (385) 244-1140 carbonarchitects.us

PROJECT:

SSL FINANCE
OFFICE REMODEL

220 MORRIS AVE. SOUTH SALT LAKE CITY UT 84115

PROJECT NO 1128-022
REVISION DATE

ISSUED

NO. DATE DESCRIPTION

1.
2.




ADA REQUIREMENTS


SCALE: 1/4" = 1'-0"


DRAWN BY:

G002

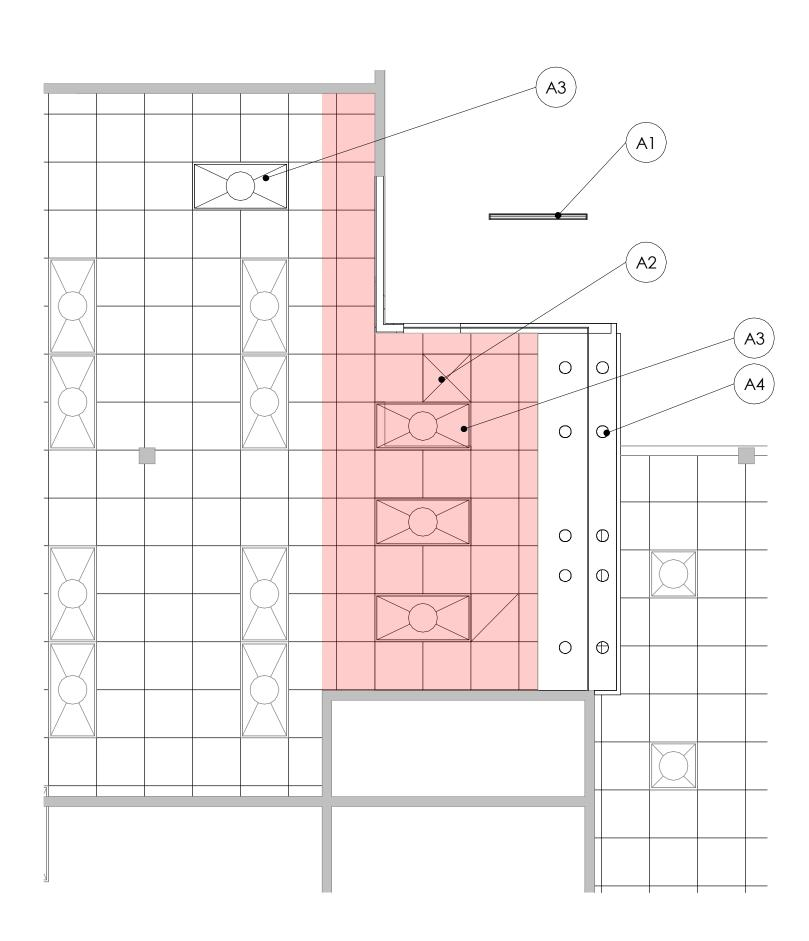

REFLECTED CEILING PLAN
1/4" = 1'-0"

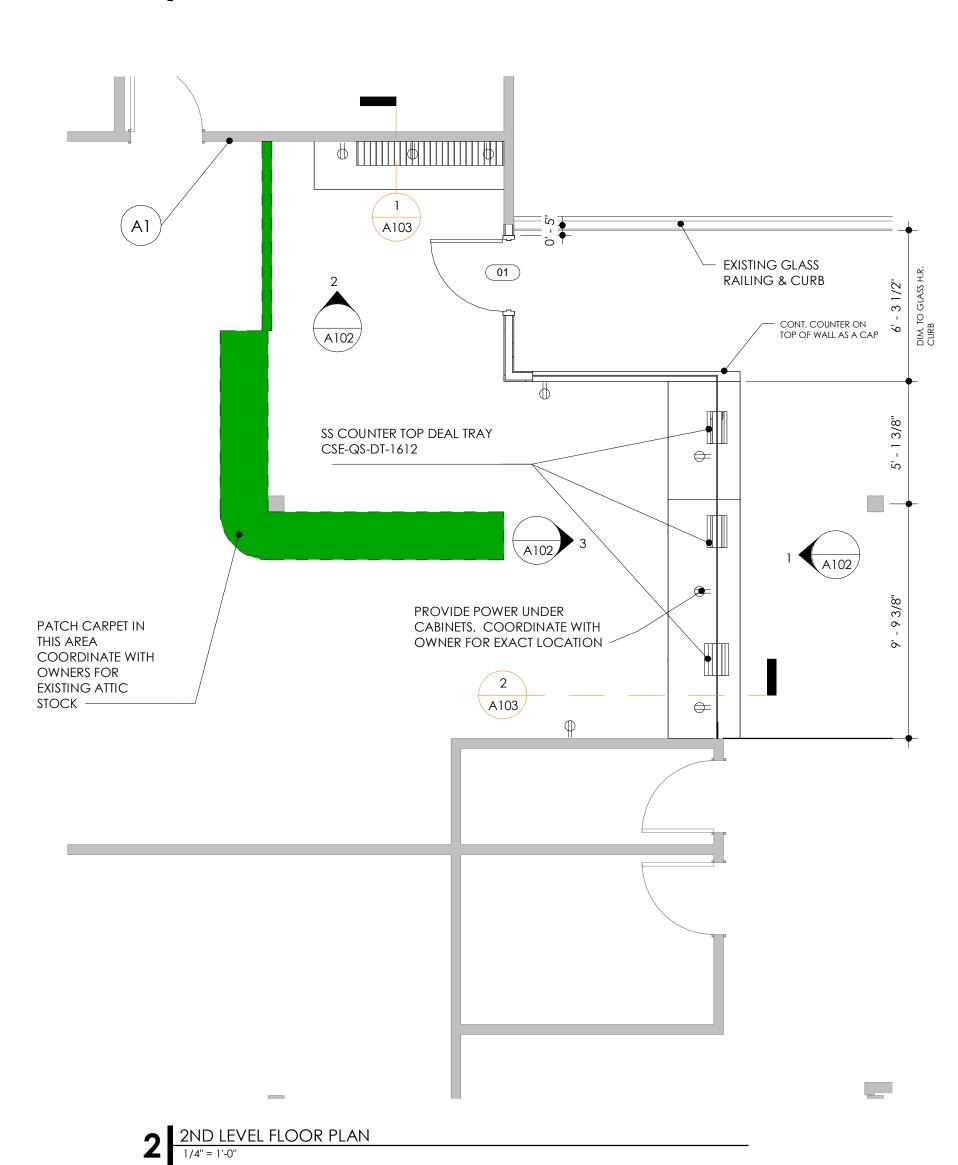


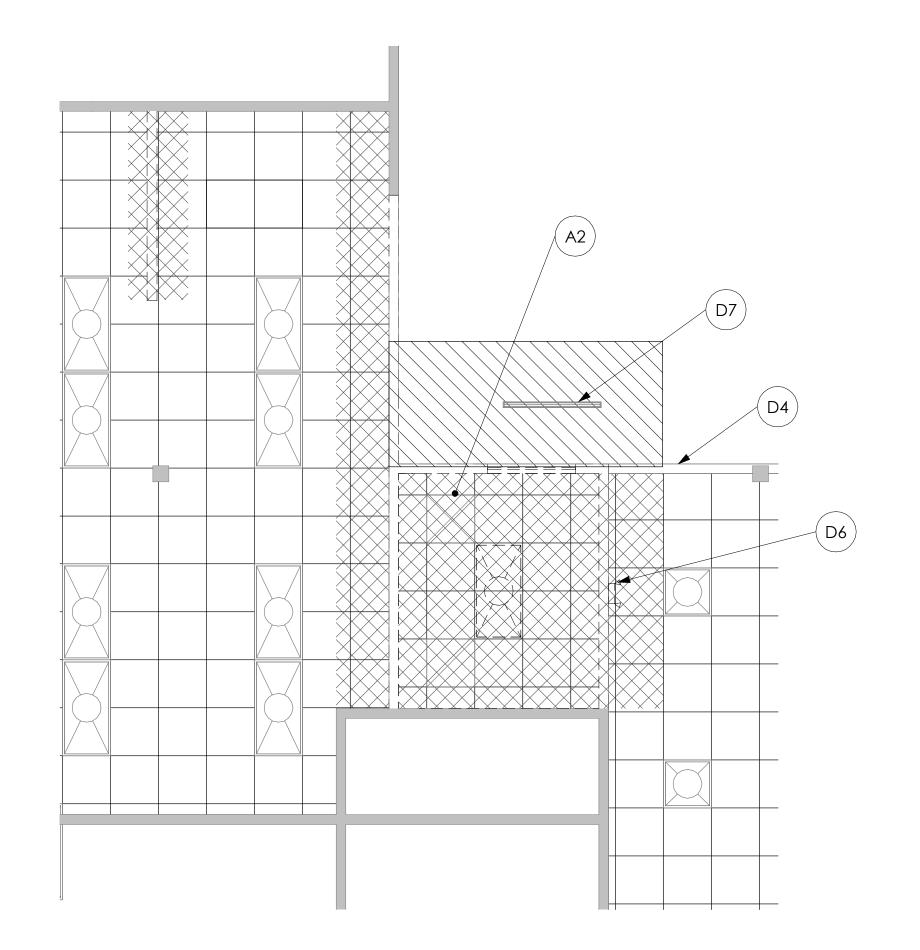

4 REFLECTED CEILING DEMOLITION PLAN

1/4" = 1'-0"

DEMOLITION PLAN
1/4" = 1'-0"

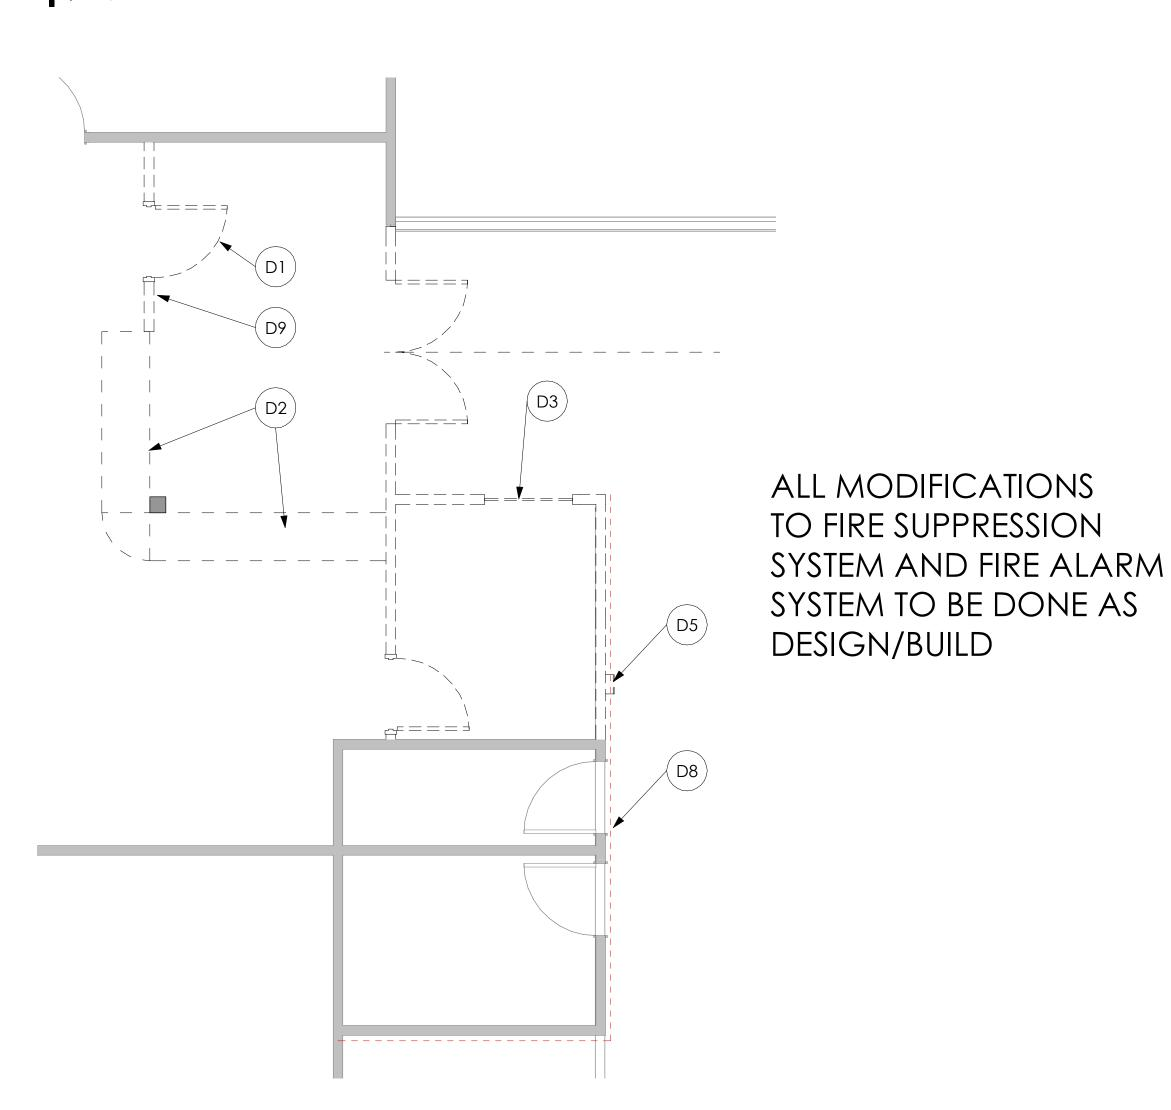

GENERAL NOTES

ALL DIMENSIONS ARE TO GRID, CENTERLINE, FACE OF FOUNDATION WALL (U.N.O.), FACE OF STUD FRAMING

- ALL GYP. BOARD WALLS AND CEILINGS ARE TO BE PAINTED U.N.O. - SEE FINISH SCHEDULE.
- ALL INTERIOR HOLLOW METAL DOOR AND WINDOW FRAMES SHALL BE PAINTED

CARBON

2032 Lincoln Avenue

T: (385) 244-1140

**OFFICE** 

**REMODEL** 

220 MORRIS AVE.

DATE:

ISSUED NO. DATE

PROJECT NO:

REVISION

**SOUTH SALT LAKE CITY UT 84115** 

09/08/23

1128-022

DATE

DESCRIPTION

carbonarchitects.us

**SSL FINANCE** 

Suite 102 Ogden, UT

PROJECT:

84401

- ALL DOOR OPENINGS ARE LOCATED WITH THE HINGE SIDE 4" OFF THE CORNER
- VERIFY ON-SITE HANDRAILS AND INSTALL AT APPROPRIATE LOCATIONS

UNLESS NOTED OTHERWISE.

- PROVIDE CONTROL JOINTS IN GYPSUM BOARD AT ALL RUNS OVER 30'-0"
- FIRE STOPPING MATERIALS FOR NON-FERROUS PIPE, CONDUIT AND OTHER SYNTHETIC MATERIALS SHALL BE COMPATIBLE WITH EACH OTHER.
- CABINET WIDTH DIMENSIONS ARE FOR BID PURPOSES ONLY AND MUST BE FIELD
- MAXIMUM HEIGHT OF OUTLETS ON COUNTERS TO BE 44". OTHER OUTLETS MUST BE A MINIMUM OF 15" OFF FLOOR TO A MAXIMUM OF 48"
- PROVIDE GRAB BAR BLOCKING AT ALL GRAB BAR LOCATIONS.
- PROTECT ALL (E) TO REMAIN FLOORING AND WALLS THROUGHOUT CONSTRUCTION.
- OWNER WILL OCCUPY THE SPACE DURING CONSTRUCTION. COORDINATE SHUTDOWSN, NOISE, ETC. WITH OWNER.

### **KEYNOTES**

#### DEMOLITION

#### NOTE: NOT ALL KEYNOTES WILL BE USED

- REMOVE AND STORE EXISTING DOOR, FRAME, & HARDWARE. REUSE FOR DOOR #01. REPAINT DOOR FRAME AND RESTAIN DOOR. MATCH EXISTING FINISHES
- REMOVE AND DISPOSE OF EXISTING MILLWORK
- REMOVE AND DISPOSE OF EXISTING WINDOW AND FRAME
- D4 (E) DRYWALL HEADER
- RELOCATE (E) FIRE EXTINGUISHER. COORDINATE WITH FIRE MARSHALL FOR **NEW LOCATION**
- REMOVE EXISTING EMERGENCY LIGHT -COORDINATE WITH BUILDING OFFICIAL FOR **NEW LOCATION**
- EXISTING SLOT DIFFUSER REUSE AND MOVE

TO NEW LOCATION

D8 REMOVE ALL WALL COVERING INDICATED BY RED LINE. PREP WALL FOR PAINT. PAINT

TO MATCH ADJACENT COLOR.

REMOVE AND RELOCATE ELECTRIC STRIKE AND SENSOR TO DOOR 001

# **KEYNOTES**

#### NOTE: NOT ALL KEYNOTES WILL BE USED

- EXISTING SLOT DIFFUSER RELOCATE AS NEEDED
- REUSE EXISTING SUPPLY AND RETURN GRILLS
- A3 NEW 2X4 LIGHTS MODEL LITHONIA CONTRACTOR SELECT STACK SWITCH. CONNECT TO EXISTING LIGHTING CIRCUIT
- A4 NEW RECESSED 5" CAN LIGHT. LITHONIA CONTRACTOR SELECT 65EMW




**PLANS** 


NOT IN SCOPE

□□□□□□□ NEW WALLS ☐ ☐ ☐ ☐ DEMOLISHED **BUILDING ELEMENTS** 

EXISTING WALLS

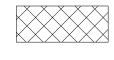

AREA OF EXISTING
GRID CEILING TO BE
REMOVED GRID CEILING TO BE AREA OF EXISTING

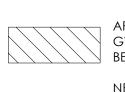


LEGEND

SITE PLAN


GWB CEILING TO BE REMOVED NEW GRID CEILING MATCH AND CONNECT INTO EXISTING

SCALE: As indicated

DRAWN BY:

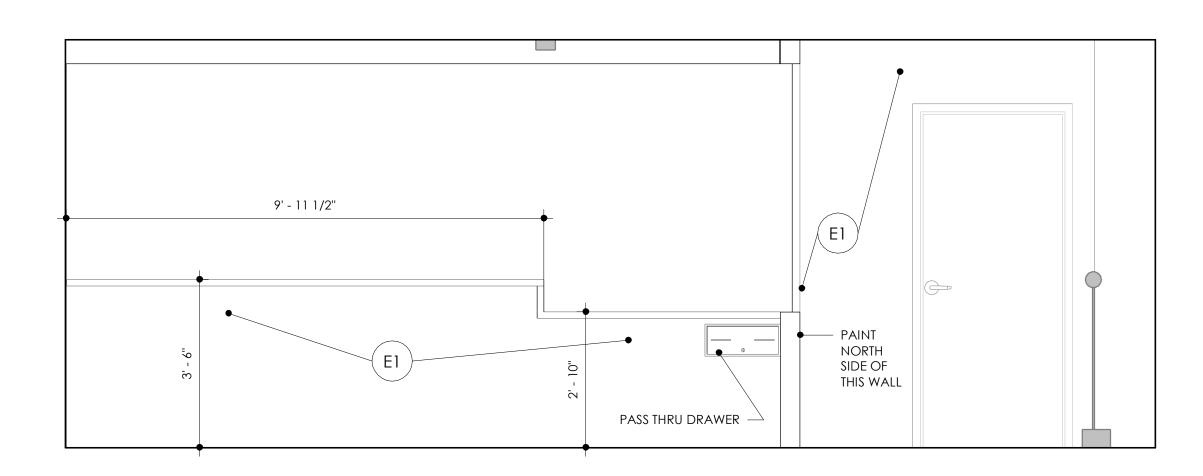


CUSTOMER SIDE OF COUNTER
1/2" = 1'-0"

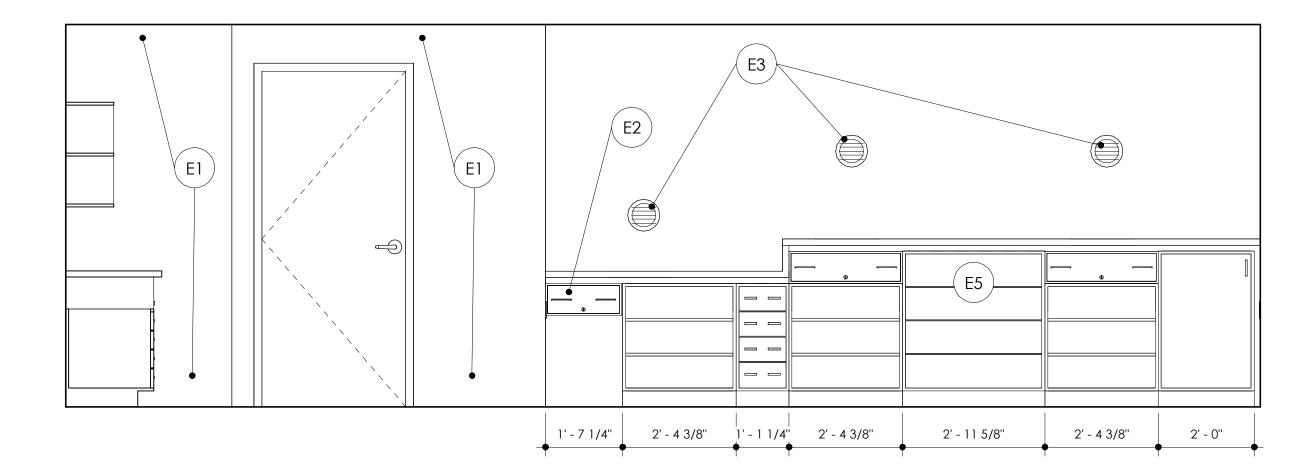

3 EMPLOYEE SIDE OF COUNTER
1/2" = 1'-0"

ALL COUNTERS TO BE - FORMICA 912-58 STORM/MATTE FINISH ALL CABINETS TO BE - FORMICA 9243 - 58 ZEN GRAY/MATTE FINISH INTERIOR OF ALL CABINETS TO BE WHITE MELAMINE

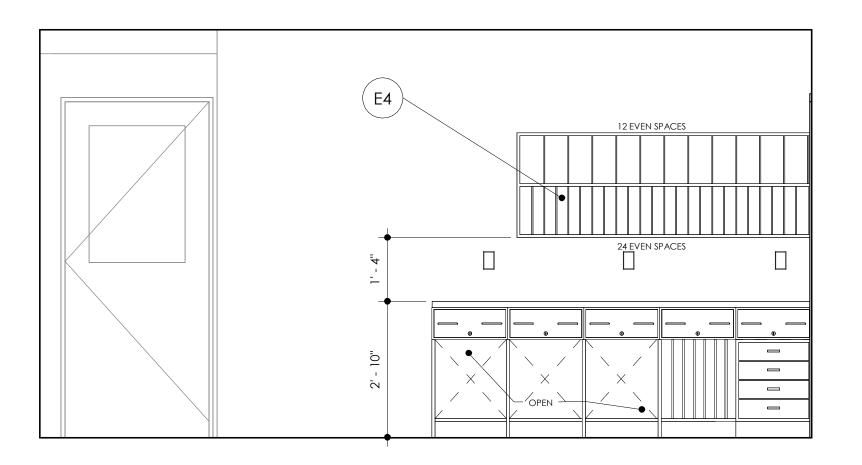

MAIL CENTER
1/2" = 1'-0"

## KEYNOTES

INTERIOR ELEVATIONS NOTE: NOT ALL KEYNOTES MAY BE USED

E1 PAINT - MATCH EXISTING

E2 E2 - CASH DRAWER ACCESSIBLE FROM BOTH SIDES OF THE COUNTER

E3 - VOICE SPEAKTHRU - MODEL #CSE-QS-NV OR APPROVED EQUAL

E4 E4 - DIVIDERS TO BE PROVIDED BY OWNER. COORDINATE SIZES WITH OWNER.

E5 E5 - 22" DEEP (MIN.) ROLLOUT SHELF

CARBON ARCHITECTS

2032 Lincoln Avenue Suite 102 Ogden, UT 84401

T: (385) 244-1140 carbonarchitects.us

PROJECT:
SSL FINANCE OFFICE **REMODEL** 

220 MORRIS AVE. SOUTH SALT LAKE CITY UT 84115

DATE: 09/08/23 PROJECT NO: 1128-022 DATE **REVISION** 

ISSUED NO. DATE DESCRIPTION



**INTERIOR** 

**ELEVATIONS** 

1/2" = 1'-0"



NOT IN SCOPE EXISTING WALLS


□□□□□□ NEW WALLS □ □ □ □ DEMOLISHED
BUILDING ELEMENTS

AREA OF EXISTING
GRID CEILING TO BE
REMOVED


DRAWN BY:

SCALE:

AREA OF EXISTING GWB CEILING TO BE REMOVED NEW GRID CEILING MATCH AND CONNECT INTO EXISTING

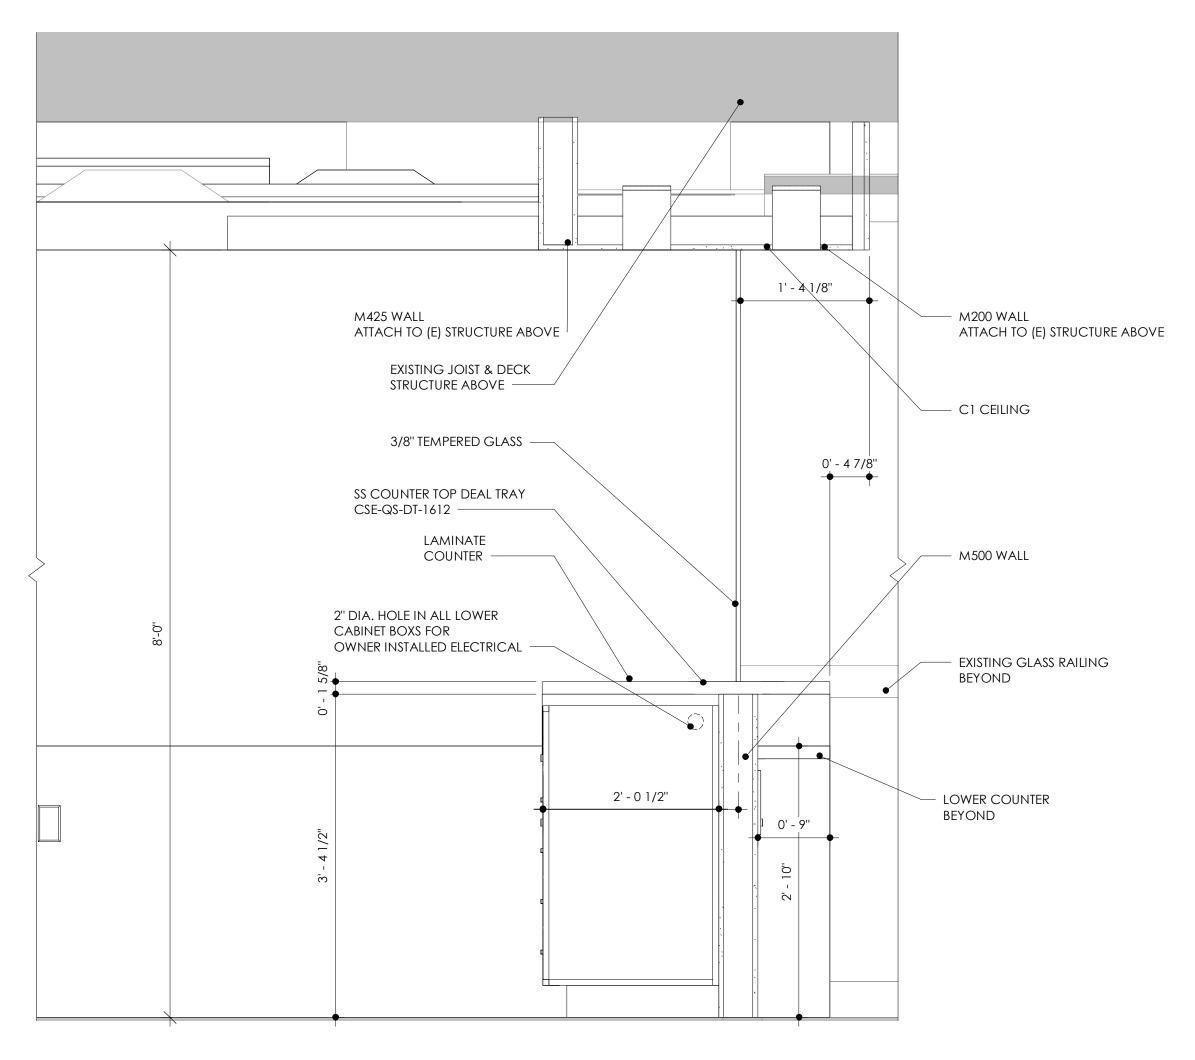

2 SECTION 2

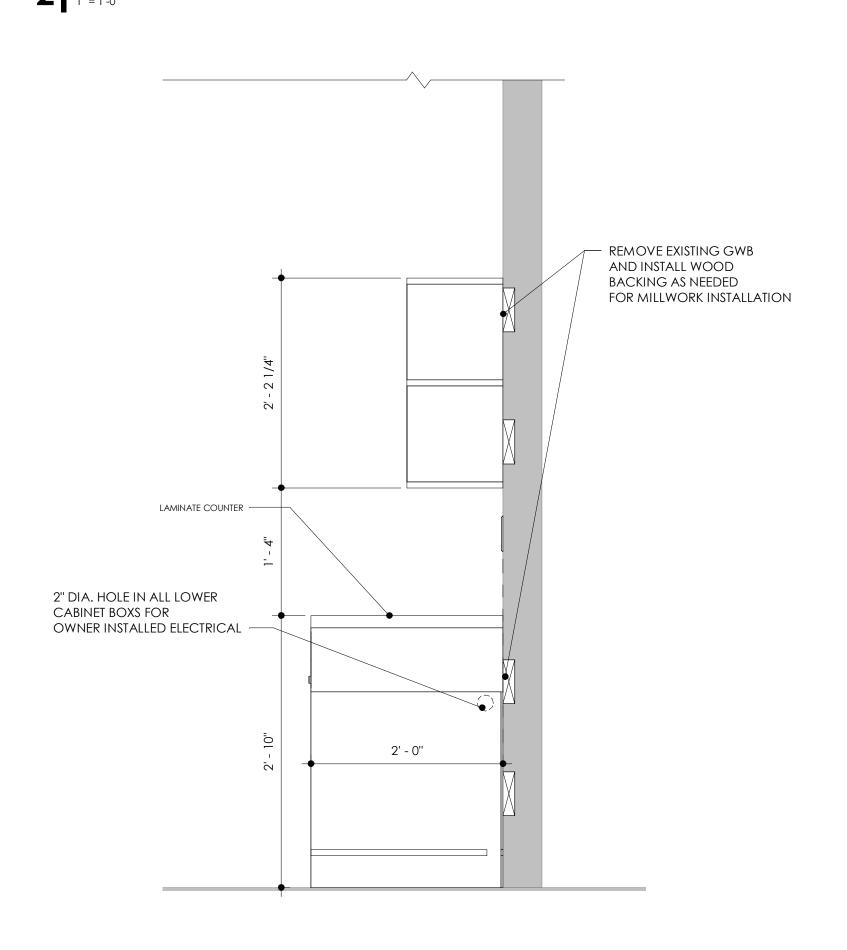

etail I = 1'-0"

## GENERAL NOTES

#### REFLECTED CEILING PLAN

- 1. COORDINATE WITH MECHANICAL DOCUMENTS FOR ACCESS TO DAMPERS AND MECHANICAL EQUIPMENT. PROVIDE ACCESS AND IDENTIFICATION FOR ALL FIRE AND SMOKE DAMPERS IN COMPLIANCE WITH IBC 710.5.2.2.1.
- 2. COORDINATE WITH MECHANICAL DOCUMENTS FOR CORRECT LOCATION OF CEILING DIFFUSERS, AUTOMATIC FIRE SUPPRESSION SPRINKLER HEADS AND ACCESS PANELS.
- 3. FIRE SPRINKLER LOCATIONS ARE NOT INDICATED.
- 4. SEE ELECTRICAL DRAWINGS FOR FIXTURE SPECIFICATIONS AND REQUIREMENTS.
- 5. COORDINATE WITH ELECTRICAL DOCUMENTS FOR CORRECT LOCATION OF CCTV, SMOKE DETECTORS, FIRE ALARMS, EXIT SIGNS AND LIGHTS AND SECURITY SYSTEMS.
- 6. PROVIDE GYPSUM BOARD CONTROL AND EXPANSION JOINTS IN CEILINGS AND SOFFITS PER STANDARD CONSTRUCTION PRACTICES AND PER GYPSUM MANUFACTURER'S WRITTEN RECOMMENDATIONS.
- 7. CEILING PLAN DIMENSIONS ARE TO FACE OF GYPSUM WALL BOARD, TYPICAL.
- 8. CEILING HEIGHTS ARE MEASURED FROM TOP OF PLYWOOD OR SLAB.
- P. LAY IN ACOUSTIC TILE CEILING SYSTEM SEISMIC BRACING REQUIREMENTS SEE DETAIL ?/????.
- ALL CEILINGS SHALL COMPLY WITH IBC REQUIREMENTS FOR LAY IN CEILINGS IN SEISMIC CATEGORY B.
- 11. ALL GYPSUM BOARD CEILINGS SHALL BE PAINTED SEE FINISH SCHEDULE



2032 Lincoln Avenue Suite 102 Ogden, UT 84401

T: (385) 244-1140 carbonarchitects.us

PROJECT:

SSL FINANCE OFFICE REMODEL

220 MORRIS AVE. SOUTH SALT LAKE CITY UT 84115

DATE: 09/08/23
PROJECT NO: 1128-022
REVISION DATE

ISSUED

NO. DATE DESCRIPTION

1.



**DETAILS** 

SCALE: As indicated

DRAWN BY:

A103